

ABBREVIATIONS

			•		
ABA /	Λ B. Q. /Γ	nul	Daliki E Illinia	Upp	HEADER
ABV	ABUA CENT	DЦ	DOUBLE HUNG	LIDR UTC	
LDA	ADJACENT	D5	DONNSPOUT	HTG	HEATING
A/C	AIR CONDITIONING ALTERNATE	D DV/C	DRAIN	HVA <i>C</i>	HEATING/VENTILATION/AIR COND
ALT	· ·	DWG	DRAWING	ΠŢ	HEIGHT
AB	ANCHOR BOLT	DF 55	DRINKING FOUNTAIN	ЦС	HOLLOW CORE
ΔD	AREA DRAIN	EF = ^	EACHFACE	HOR.	HORIZONTAL
BRG	BEARING	EA -	EACH	ЦB	HOSE BIBB
ВМ	BENCHMARK	E.	EA5T	INCL	INCLUDE
BLK	BLOCK	EP	ELECTRICAL PANELBOARD	ID.	NSIDE DIAMETER
BLK'G	BLOCKING	EL.	ELEVATION	INT	INTERIOR
BD	BOARD	ENC	ENCL05URE	٦T	TMIOL
B5	BOTH SIDES	E.Q	E <i>Q</i> UAL	J	J015T
BOT	BOTTOM	EQP	Eauipment	KIT	KITCHEN
BLDG	BUILDING	$EX\mathcal{C}\Delta$	EXCAVATE	KO	KNOCKOUT
BUR	BUILT UP R <i>OO</i> FING	EΧΠ	EXHAUST	LBL	LABEL
CAB	CABINET	EXG	EXISTING (E)	LAB	LABORATORY
C5MT	CASEMENT	EB	EXPANSION BOLT	LB	LAG BOLT
CI	CAST IRON	EXP	EXP <i>05</i> ED	LAM	LAMINATED
CLG	CEILING	F05	FACE OF STUD	LAV	LAVATORY
CEM	CEMENT	FA5	FASTEN	L	LENGTH
CLR	CLEAR	FIN	FINISH (ED)	LT	ЦСЦТ
COL	COLLIMN	FFE	FINISH FLOOR ELEVATION	LC	LIGHT CONTROL
COMPO	COMPOSITION	FFL	FINISH FLOOR LINE	LW	UGHT WEIGHT
CONC	CONCRETE	FΑ	FIRE ALARM	LTL	LINTEL
CMU	CONCRETE MASONRY UNIT	FE	FIRE EXTINGUISHER	LL	LIVE LOAD
CONST	CONSTRUCTION	FP	FIREPROOF	LVR	LOUVER
CONT	CONTINUOUS	FLG	FLAJHING	ΜЦ	MANHOLE
CJ	CONTROL JOINT	FLR.	FLOOR (ING)	MFR.	MANUFACTURE (ER)
CORR	CORRUGATED	FD	FLOOR DRAIN	 МДБ	MA30NRY
CTR	COUNTER	, FLUR	, FLUORESCENT	MTL	MATERIAL
C5	COUNTER SINK	F5	FULL SIZE	МДХ	MAXIMUM
DL	DEAD LOAD	FB0	FURNISH BY OTHERS	MC	MEDICINE CABINET
DEMO	DEMOLISH	FUR	FURRED (ING)	MBR	MEMBER
DTL	DETAIL	GA	GAUGE, GAGE	MET	METAL
DIAG	DIAGONAL	97 GV	GALVANIZED	MIN	MINIMUM
DIA	DIAMETER	9 ¥ GL	GLASS	MIR	MIRROR
DIM	DIMENSION	9L GB	GRAB BAR	MISC	MISCELLANEOUS
DIN DR	DOOR	GD	GRADE	NOM	NOMINAL
VK	NUCK	42	YKAVE	NON	

NDITIONING NTS NOT TO SCALE OB3CURE ON CENTER OPENING OPPOSITE OUTSIDE DIAMETER 0VER OVERHEAD PAVEMENT PLA5TER PLATE PLATE GLASS

RETURN AIR

REVISION

ROOF DRAIN R00M

3CREEN

SECTION

SHTH SHEATHING

ROUGH OPENING

RI3ER

REV

ROW

SEC

STAINLESS STEEL 5TD 5TANDARD 5TA STATION STORM DRAIN 5TR 5TRUCTURAL TELEPHONE PLYW*oo*d TELEVISION TEG TONGUE AND GROOVE TWPOST-TENSIONED CONCRETE TOP OF WALL POUNDS PER LINEAL FOOT TYP TYPICAL POUNDS PER SQUARE FOOT UNF UNFINISHED VAPOR BARRIER VAR VARNISH VERTICAL VERT REFERENCE WATER CL03ET WATER PROOFING REFRIGERATOR WP REGISTER WWF WELDED WIRE FABRIC WEST REINFORCE (D) (ING) RETURN WIDTH

\VD

SIM

3PK

SPEC

50

5MILAR

*50*UT∐

*50*LID *CO*RE

3PEAKER

*SQ*UARE

VINDOV

WIRE MESH

WROUGHT IRON

SPECIFICATION

SQUARE FOOT

NOTES

DRAWING INDEX

COVER SHEET * THE CONTRACTOR / BUILDER SHALL BE IN CONTROL FLOOR PLAN

OF THE WORK. * THE OWNER OR CONTRACTOR SHALL OBTAIN ALL APPLICABLE PERMITS

* THE CONTRACTOR / BUILDER SHALL RIGIDLY ADHERE TO ALL LAWS, CODES AND ORDINANCES WHICH APPLY TO THIS WORK AND SHALL NOTIFY AND RECEIVE CLARIFICATION FROM THE OWNER IN WRITING OF ANY VARIATIONS BETWEEN THE CONTRACT DOCUMENTS AND GOVERNING REGULATIONS

* WHENEVER OR WHEREVER A CONFLICT BETWEEN THE DRAWINGS, SPECIFICATIONS, INDUSTRY PRACTICE, AND APPLICABLE CODES CONFLICT, THE SITUATION SHALL BE BROUGHT TO THE ATTENTION OF THE DESIGNER AND ENGINEER AND THE MOST RESTRICTIVE SHALL GOVERN * ALL WORK SHALL BE ERECTED AND INSTALLED

PLUMB, LEVEL, AND TRUE, OR TRUE TO INDICATED ANGLE, IN PROPER ALIGNMENT AND RELATIONSHIP TO WORK OF OTHER TRADES. FINISH WORK SHALL BE FREE

* ONLY THE GENERAL LOCATION OF PLUMBING, MECHANICAL AND ELECTRICAL EQUIPMENT ARE SHOWN. THE EXACT PLACEMENT SHALL BE REVIEWED IN THE FIELD BY THE CONTRACTOR AND WORKERS TO INSURE CONFORMANCE TO APPLICABLE CODES AND SPECIFICATIONS.

* THE OWNER RESERVES THE RIGHT TO REJECT ANY MATERIALS AND WORK QUALITY, WHICH IS NOT CONSIDERED TO BE IN THE HIGHEST STANDARDS OF THE VARIOUS TRADES INVOLVED. SUCH INFERIOR MATERIALS OR WORK QUALITY SHALL BE REPAIRED OR REPLACED, AS DIRECTED, AT NO ADDITIONAL COST.

* CONSTRUCTION LOADS SHALL NOT OVERLOAD THE STRUCTURE, NOR SHALL THEY BE IN EXCESS OF THE DESIGN LOADING INDICATED ON THESE DRAWINGS.

* GENERAL CONTRACTOR SHALL BE RESPONSIBLE FOR FIELD VERIFYING ALL EXISTING CONDITIONS AND REPORTING ANY DISCREPANCIES TO THE OWNER/ DESIGNER IMMEDIATELY

* THE BUILDER SHALL INVESTIGATE THE SITE DURING CLEARING AND EARTHWORK OPERATIONS FOR FILLED EXCAVATIONS OR BURIED STRUCTURES SUCH AS CESS POOLS, CISTERNS, FOUNDATIONS, ETC.. IF ANY SUCH ITEMS ARE FOUND, THE OWNER AND ENGINEER SHALL BE NOTIFIED

* SECTIONS OR DETAILS SHOWN OR NOTED APPLY TO SIMILAR CONDITIONS ELSEWHERE NOT SPECIFICALLY SHOWN * BUILDER ASSUMES ALL RESPONSIBILITY FOR USE OF THESE PLANS AT ANY OTHER LOCATION.

DETAILS DETAIL5

ELECTRICAL FLOOR PLANS

ELEVATIONS

SCHEDULES


DETAIL5

FRAMING PLANS

CR055 SECTIONS

ROOF PLAN AND DETAILS

TITLE 24

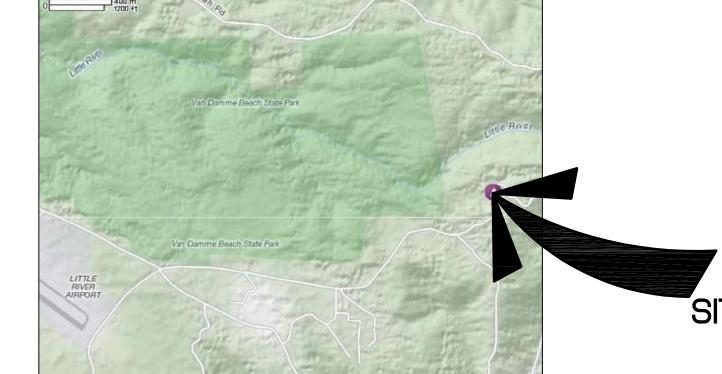

RO,

ORT

RIVER 3, CA

40633

12/13/10

AK - 1009

PLAN CHECK REV. 2/28/

DATE:

DRAWN BY:

REVISIONS:

DOR

MAR

5YMBOLS

DO APPLIANCE MARK REVISION MARK

DATUM POINT MARK

SECTION CUT MARK

SHEET

DOOR MARK

WINDOW MARK

PLUMBING MARK

PROPERTY LINE BUILDING DATA

DESIGN CRITERIA:

CODE: * 2007 CALIFORNIA BUILDING CODE (BASED ON THE 2006 IBC)

* 2007 CALIFORNIA MECHANICAL CODE (BASED ON THE 2000 U.M.C.)

* 2007 CALIFORNIA PLUMBING CODE (BASED ON THE 2000 U.P.C.)

* 2007 CALIFORNIA ELECTRICAL CODE (BASED ON THE 2005 N.E.C.) * 2007 CALIFORNIA ENERGY STANDARDS

* 2007 CALIFORNIA ENERGY CODE AND ENERGY COMMISSION STANDARDS (CECS)

OCCUPANCY: R-3 SINGLE FAMILY RESIDENCE CONSTRUCTION CLASSIFICATION: VB IMPORTANCE FACTOR = 1.0

LATERAL LOAD CRITERIA: SURFACE ROUGHNESS= E

* SEISMIC DESIGN CATEGORY= D

OCCUPANCY CATEGORY= II

DESIGN LIVE LOADS:


LONG: -122.0893


DECK5(2)


* ROOF * FLOOR 40 psf * LOFT 30 psf * EXTERIOR DECKS SITE INFO: AP#: 121-430-63 LAT: 37.4303

PROPERTY SIZE: 10.02	acres	
50UARE F00TAGE		
LIVABLE:		
MAIN LEVEL	519	• /
LOWER LEVEL	485	* /
L <i>0</i> FT	86	',
TOTAL	1090	1
cal/enen nan all	2/5	

SCALE: 1"= 30"

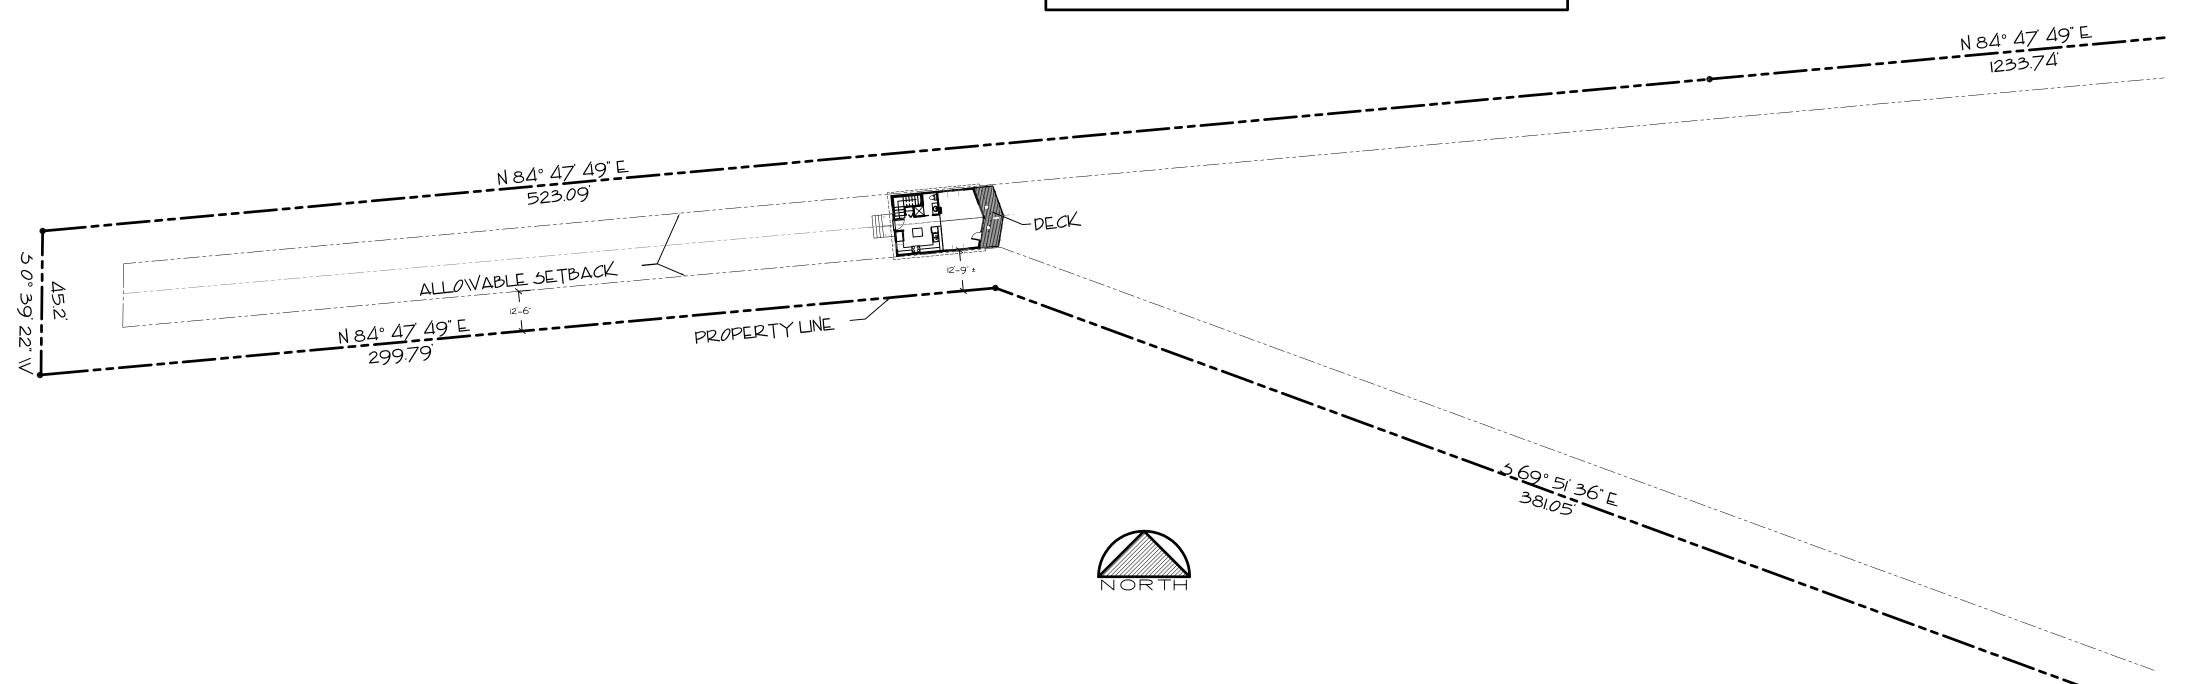

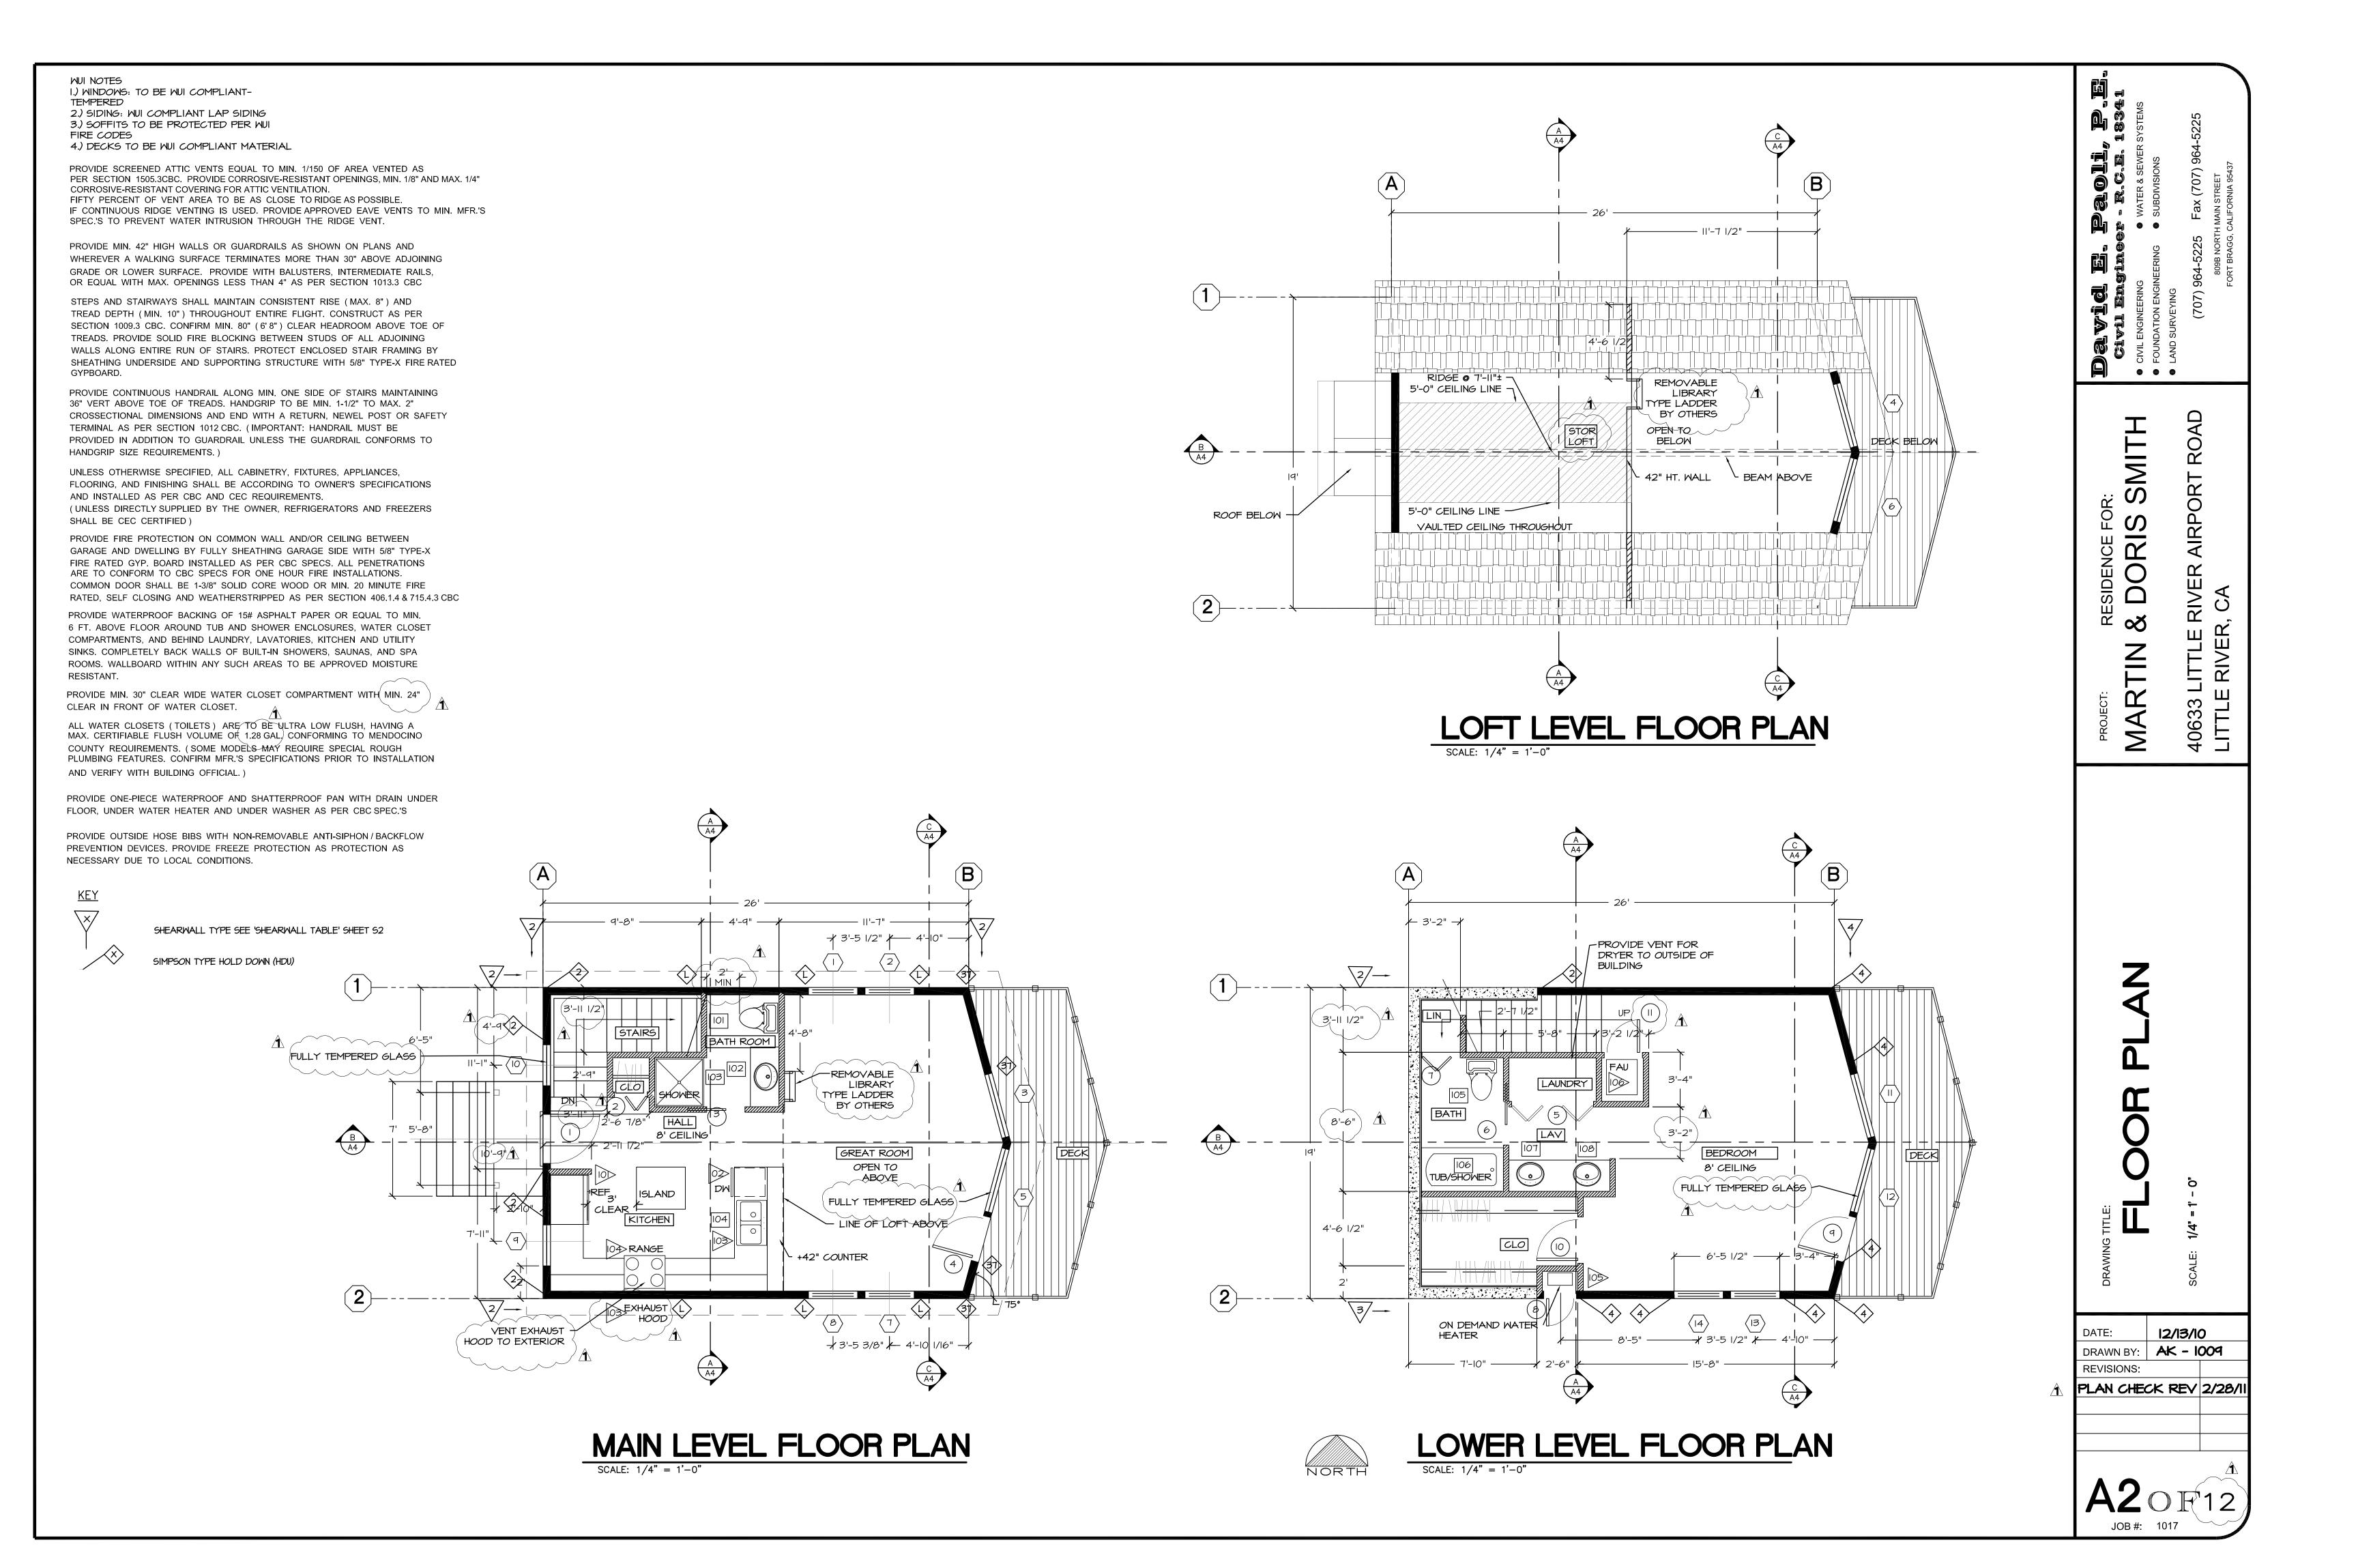


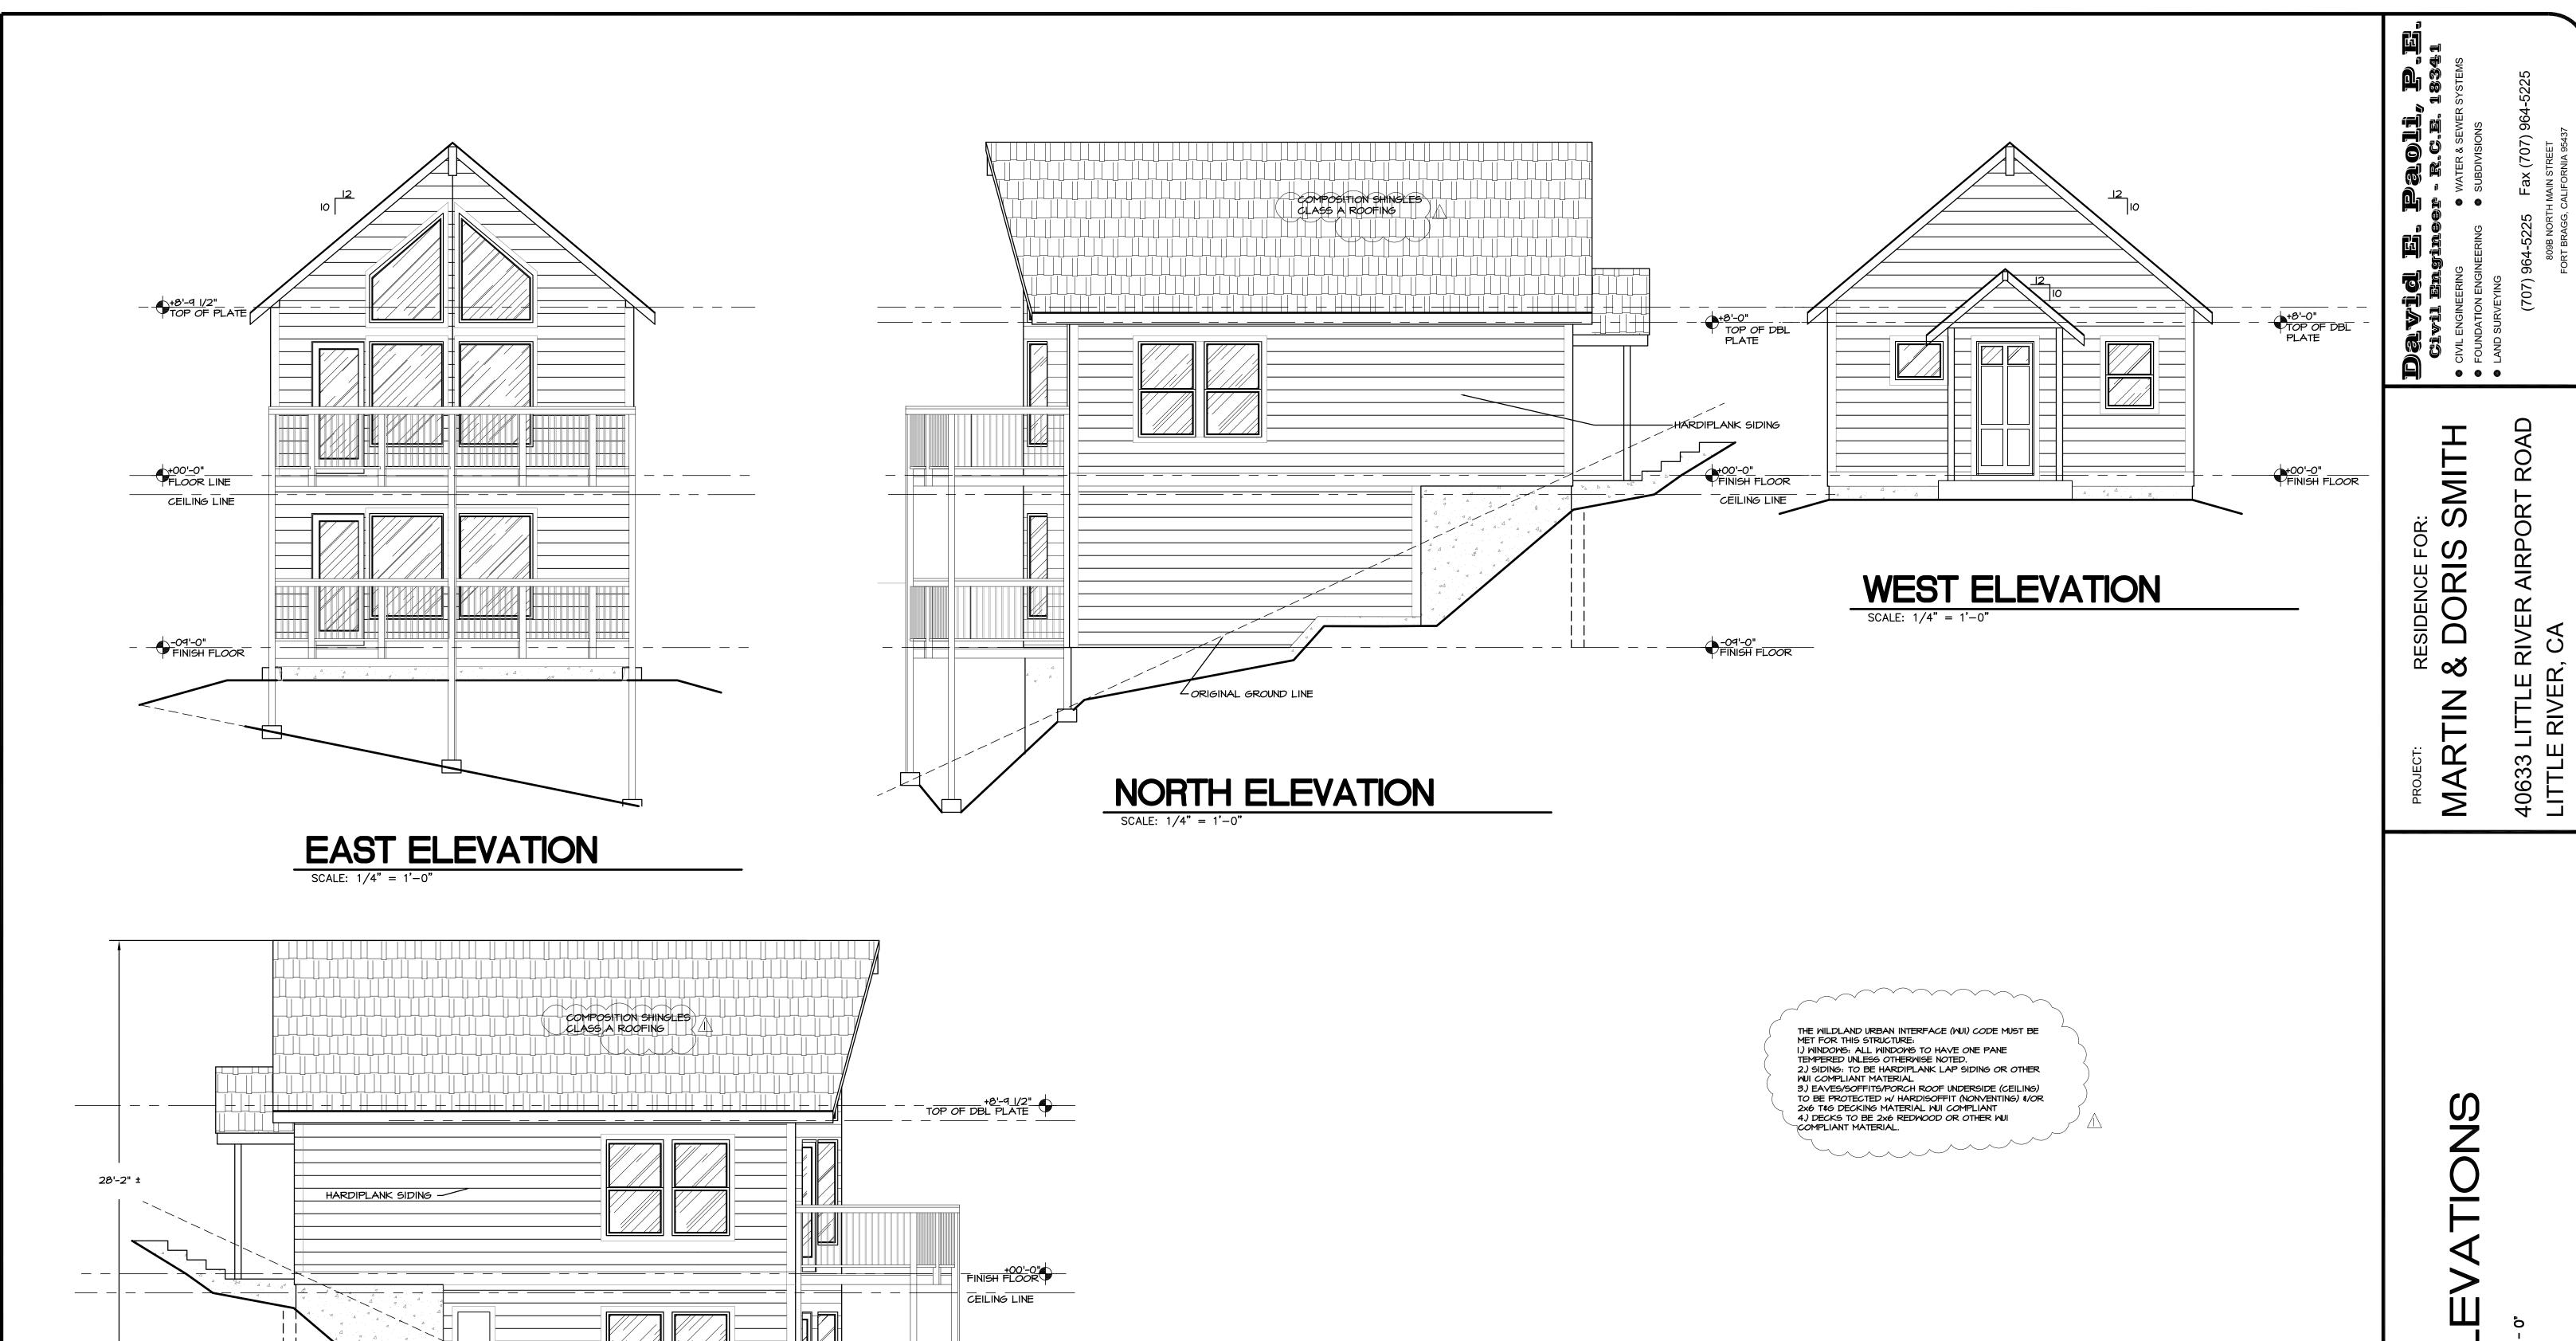


-09'-0" FINISH FLOOR


SCALE: 1/4" = 1'-0"

12/13/10 DRAWN BY: AK - 1009 **REVISIONS:** PLAN CHECK REV 2/28/

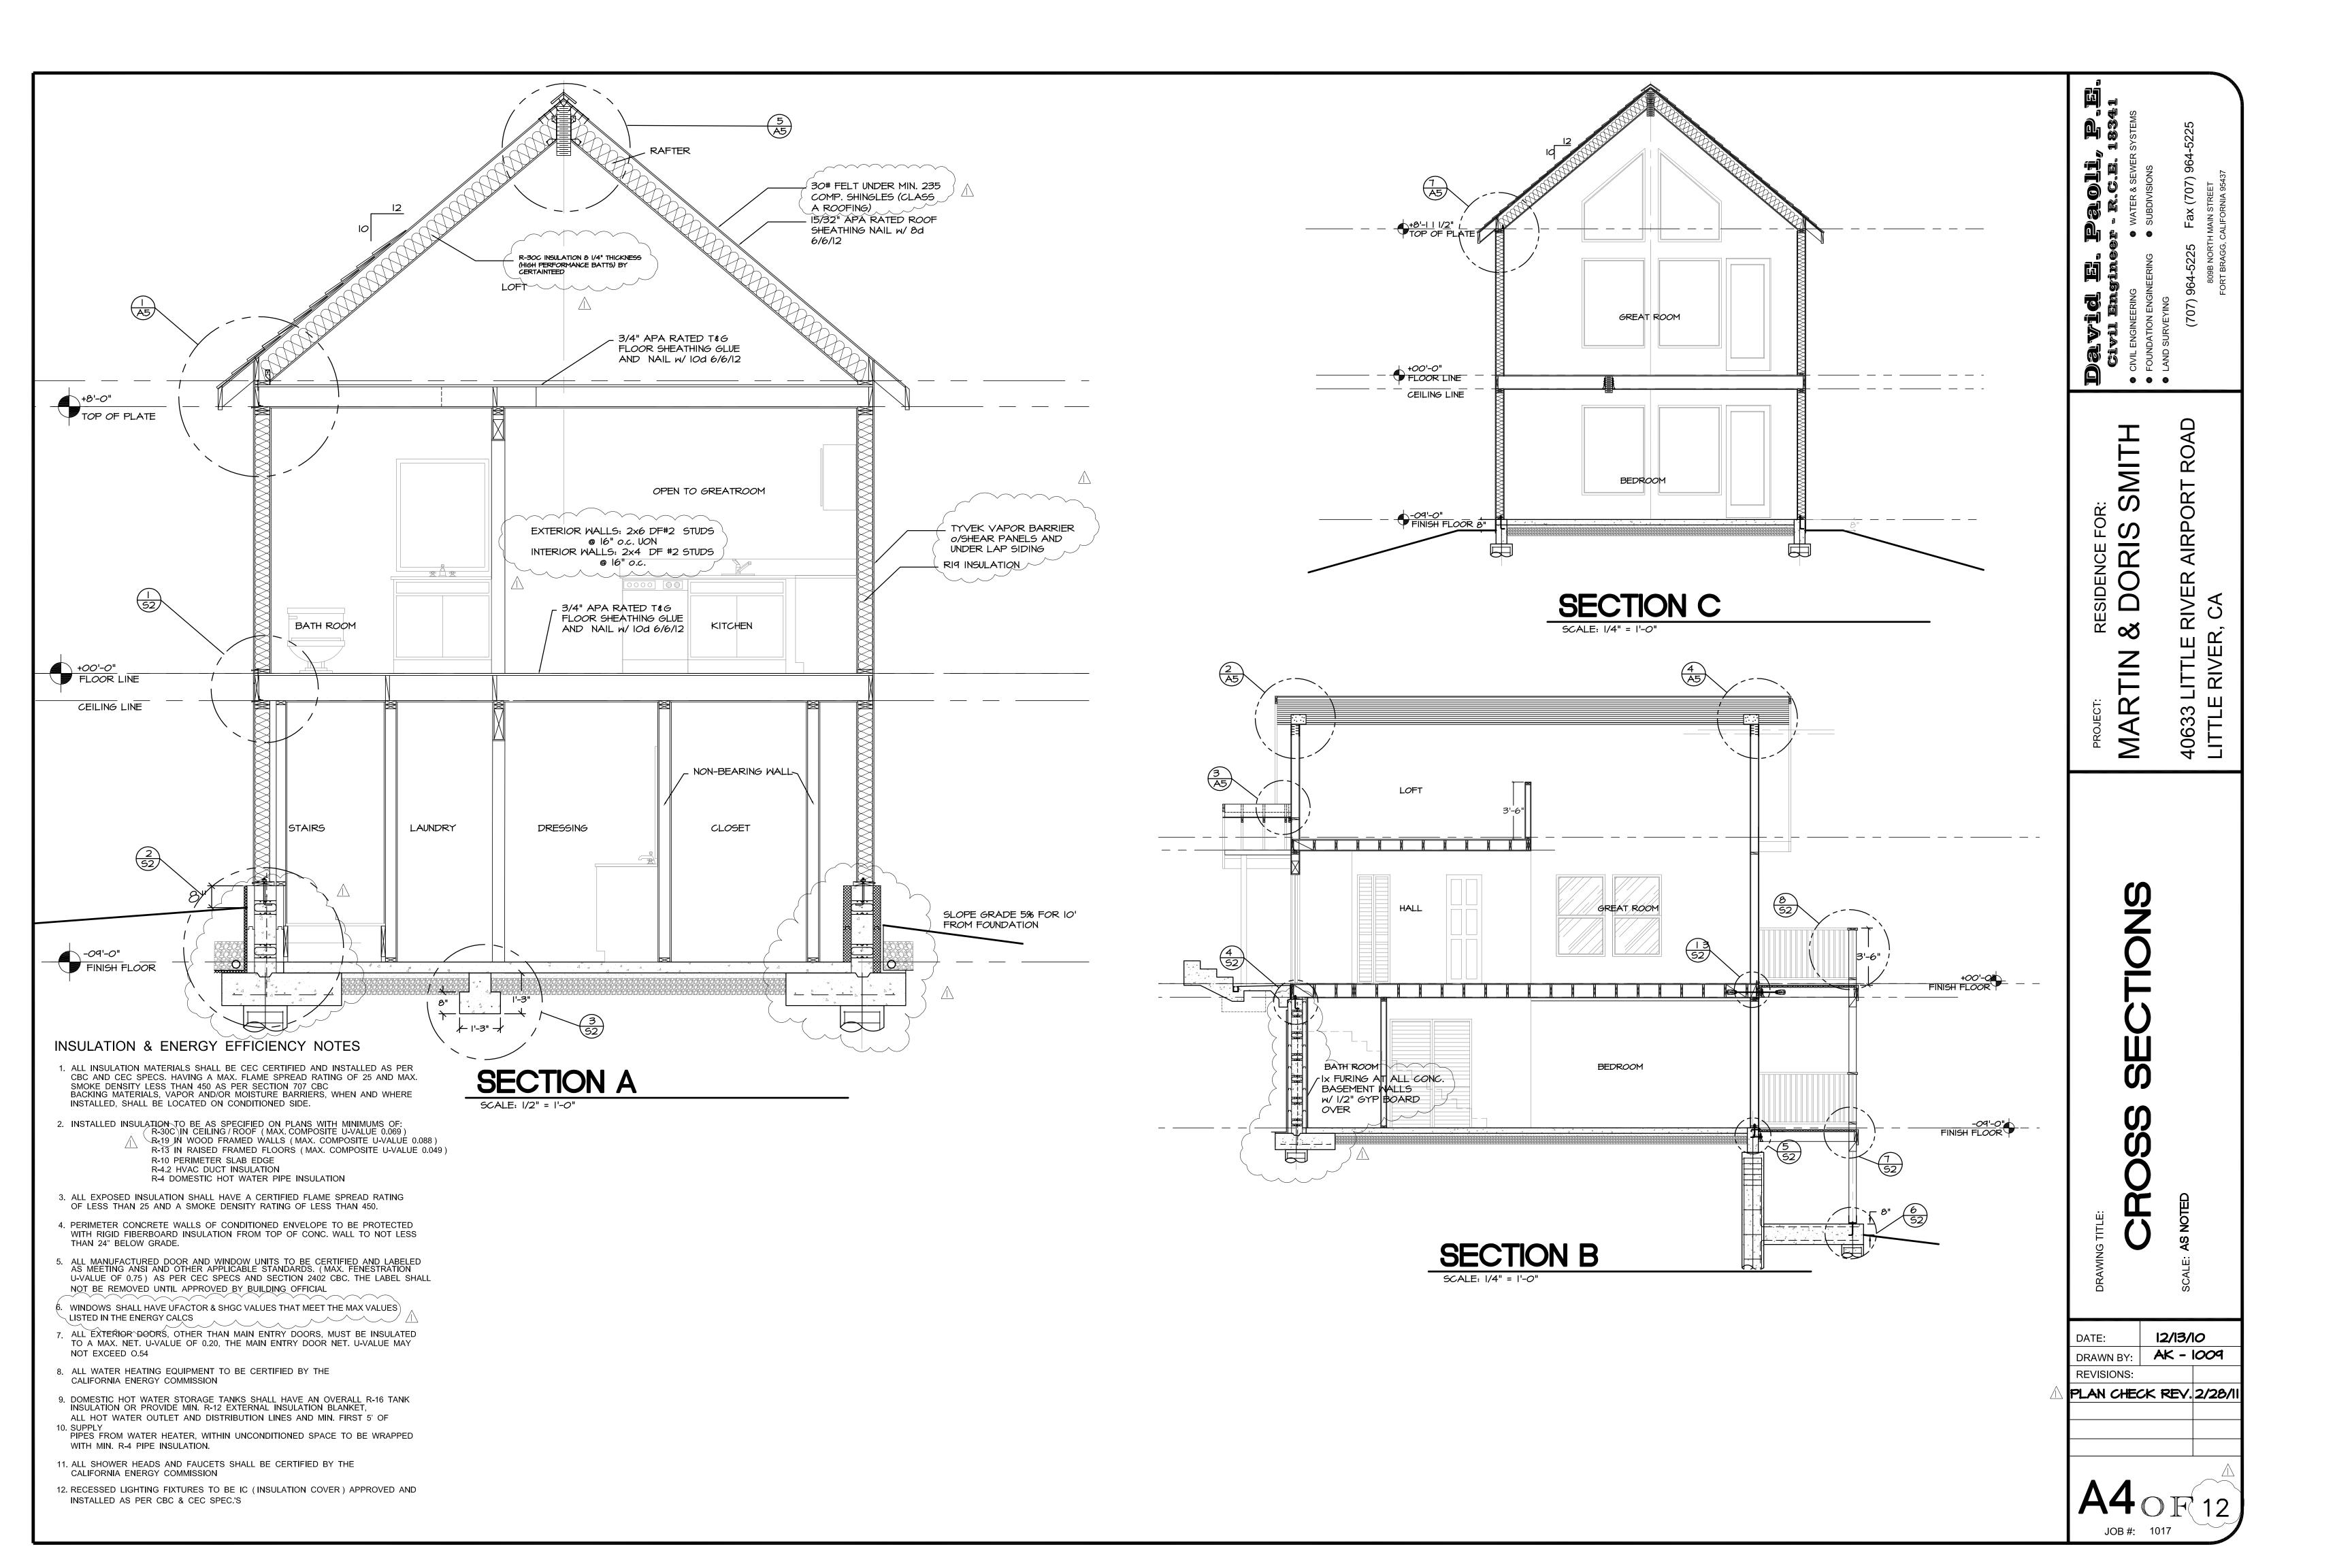

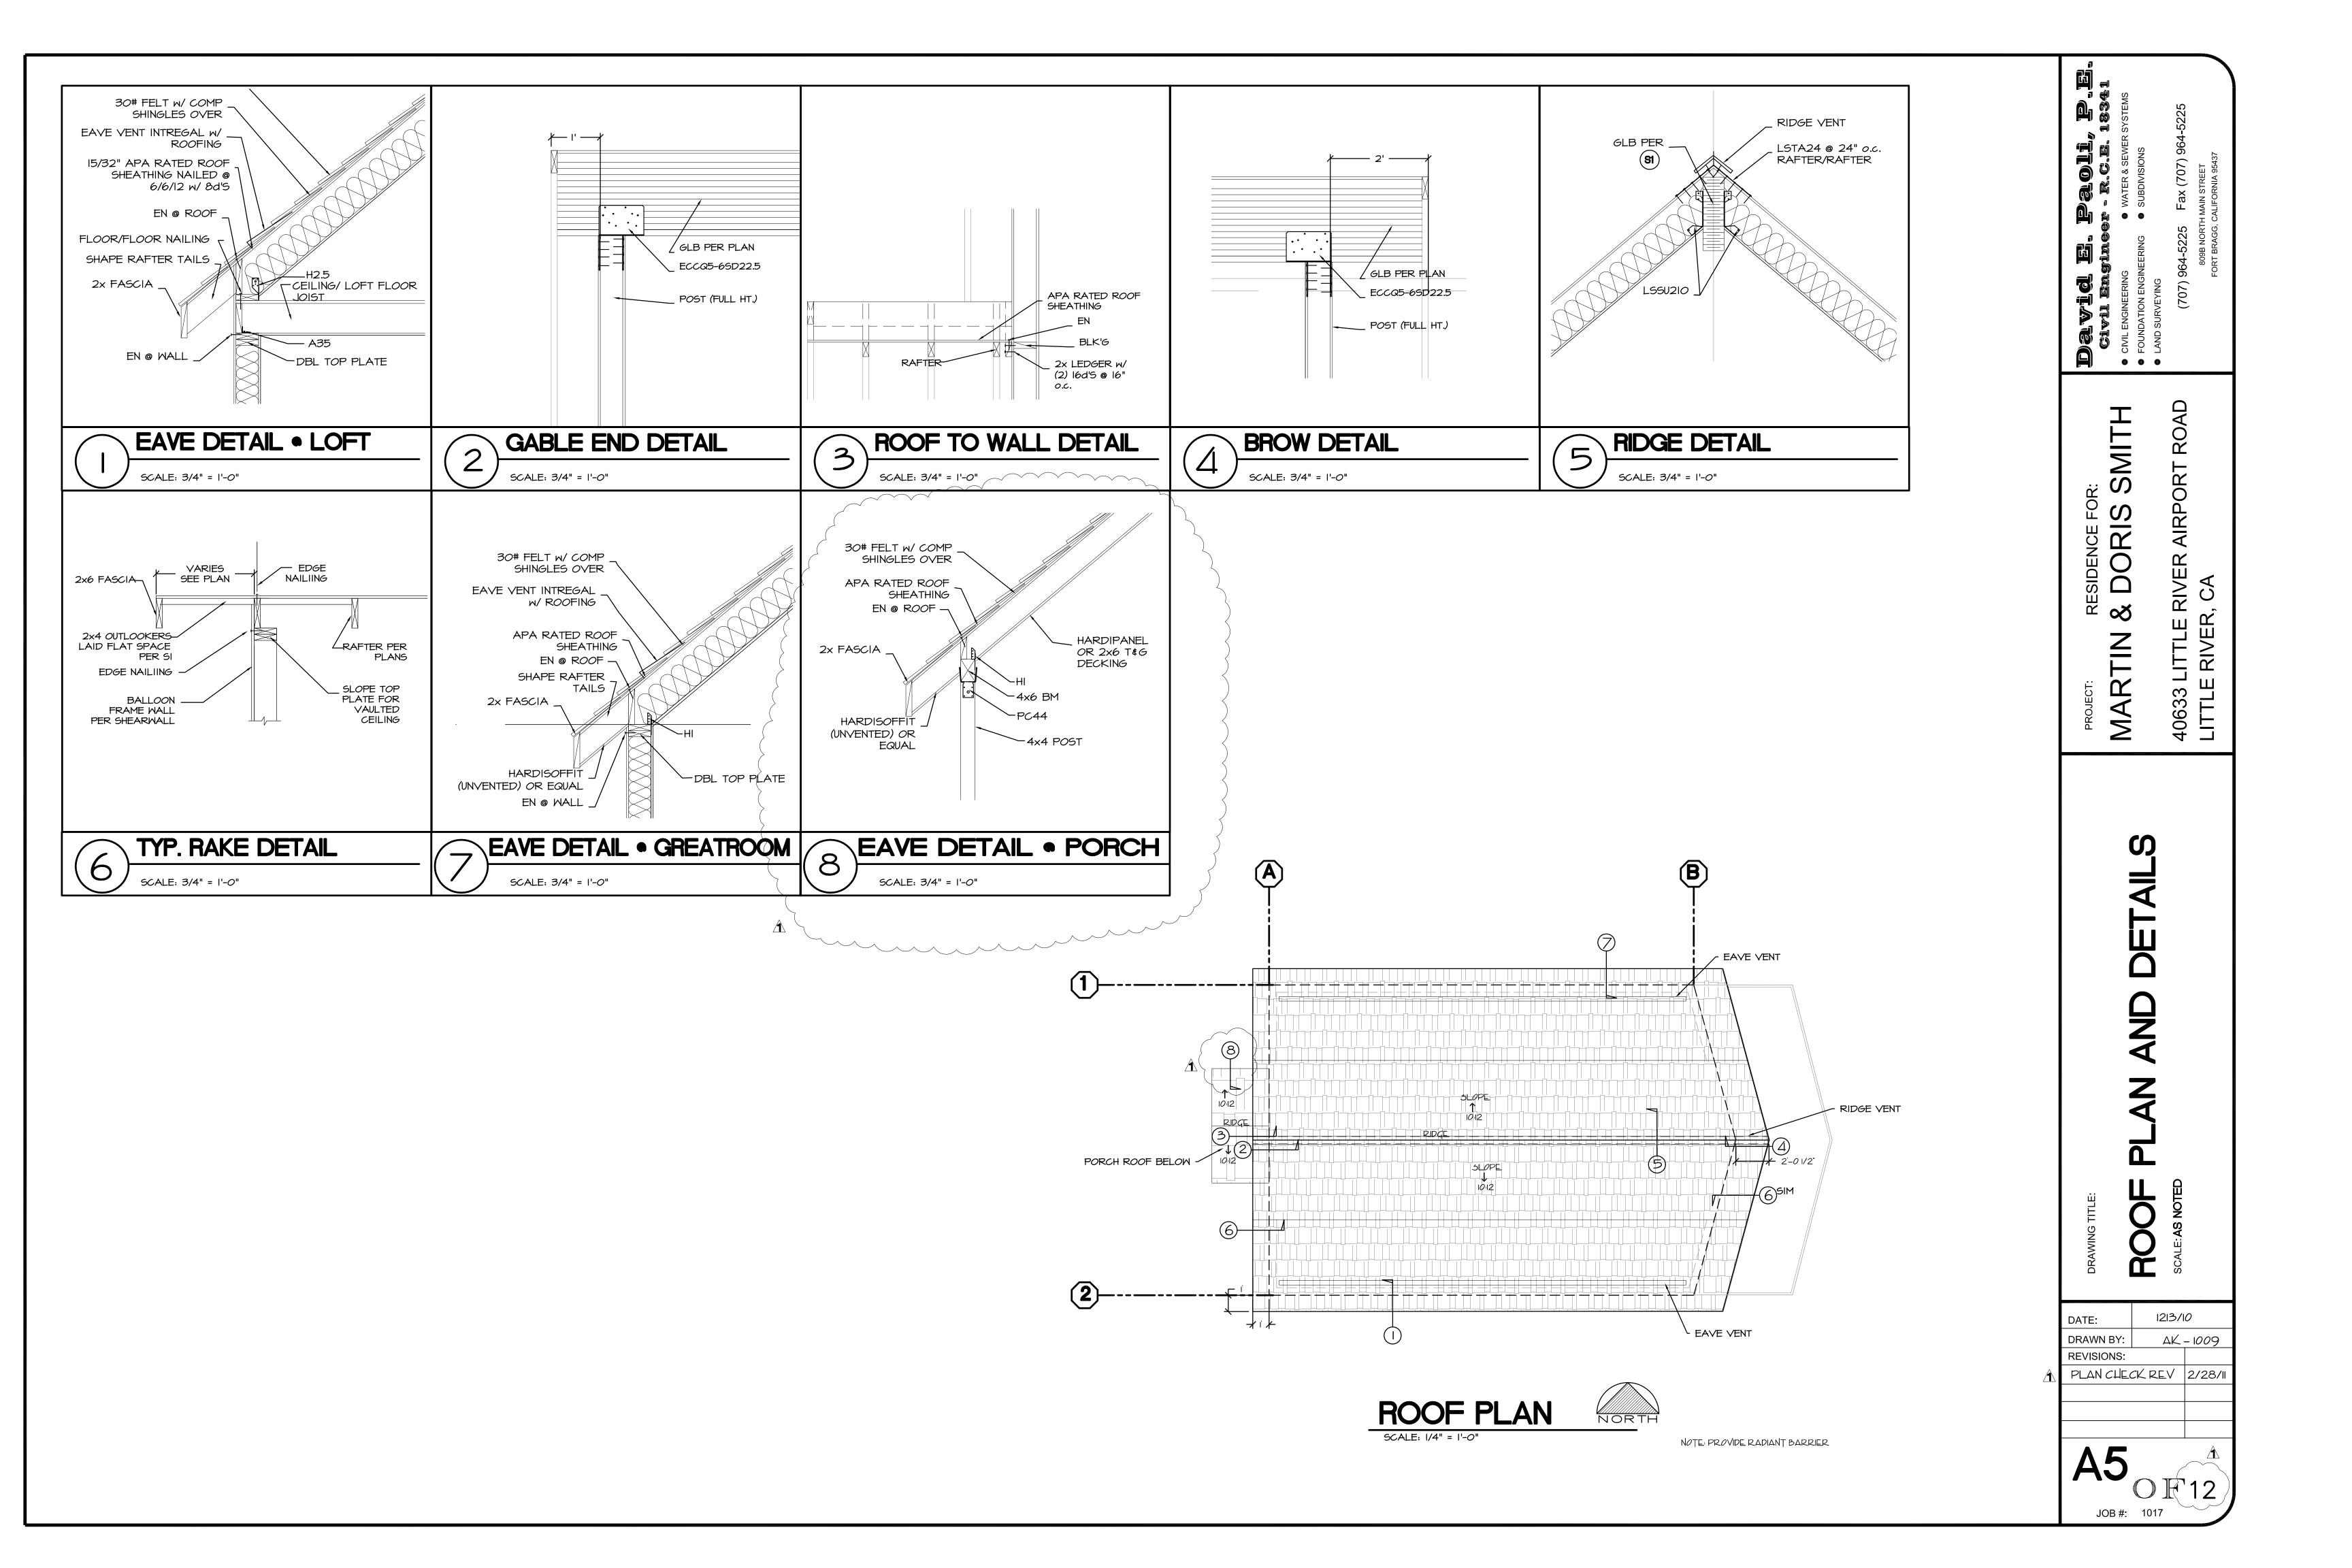

D	OOR SO	CHEDU	JLE					
SYM	WIDTH	HT.	THICK	TYPE	HC/SC	MATERIAL	LATCH	REMARKS
							OWNERS CHOICE	\wedge
	3'-0"	6'-8"	1 3/4"	PANEL- OWNERS CHOICE	SC	MOOD	ENTRY W/ DEAD BOLT	20 MIN FIRE RATED
2	2'-0"		1 3/8"	BIFOLD 2 PANEL- LOUVERED	HC		PASSAGE LATCH	
3	2'-4"		1 3/8"	PKT PANEL	HC		PRIVACY LATCH	
4	2'-6"		1 3/4"	SINGLE FRENCH	SC		PASSAGE LATCH	
5	5'-0"		1 3/8"	BIFOLD 4 PANEL- LOUVERED) HC		PASSAGE LATCH	
6	2'-6"			PKT PANEL			PRIVACY LATCH	
7	2'-4"	\		BIFOLD 2 PANEL- LOUVERED	\ /		PASSAGE LATCH	
8	1'-10"	4'-0"	1 3/4"	PANEL- OWNERS CHOICE	SC		PASSAGE LATCH	
9	2'-6"	6'-8"	1 3/4"	SINGLE FRENCH	SC		ENTRY	
10	2'-6"	6'-8"	1 3/8"	PANEL-OMNERS CHOICE	HC		PASSAGE LATCH	
(11	2'-0"	6'-8"	1 3/8"	LOUVERED DOOR	SC		PASSAGE LATCH A	
AA	3'-0"	6'-0"		GLASS SHOWER ENCLOSURE		TEMP G		OPTIONAL
BB	5'-0"	4'-0"		GLASS SHOWER ENCLOSURE		TEMP G	4	OPTIONAL

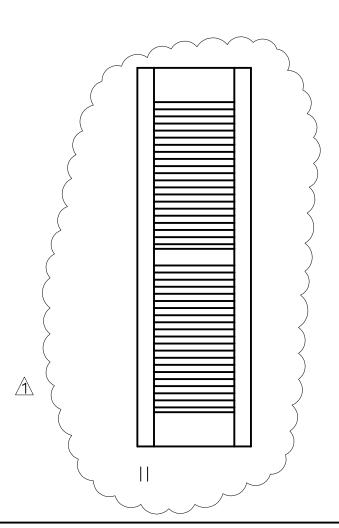

V	VINDOW	SCHE	DULE					
SYM	WIDTH	HT.	TYPE LOEWEN	FRAME	SCR.	GLAZE AREA	VENT AREA	REMARKS
	3'-0"	5'-0"	DBL HUNG	CLAD	0.0.			
2	3'-0"	5'-0"	DBL HUNG		0.0.			
3	4'-0"	6'-0"	FIXED					Â
4	4'-0"	VARIES	FIXED					
5	4'-0"	6'-0"	FIXED					TEMPERED BOTH PANES
6	4'-0"	VARIES	FIXED				\	
7	3'-0"	5'-0"	DBL HUNG		0.0.		>	
8	3'-0"	5'-0"	DBL HUNG		0.0.		>	
9	2'-6"	3'-6"	DBL HUNG		0.0.			TEMPERED BOTH PANES
10	2'-6"	2'-0"	AMNING		0.0.			
	4'-0"	6'-0"	FIXED					TEMPERED BOTH PANES
12	4'-0"	6'-0"	FIXED					
13	3'-0"	5'-0"	DBL HUNG		0.0.			
14	3'-0"	5'-0"	DBL HUNG	\	0.0.			

PL	LUMBING SCHEDULI						
SYM	ITEM	MANUFACTURE/MODEL	SIZE	COLOR	VALVES/FITTINGS	OTHER FITTINGS	REMARKS
101	MC	KOHLER 'CIMARRON'	28 3/4"x 7 5/8"x30 3/4"	OWNERS CHOICE	MANUF. TRIP LEVER		MUST ALLOW 24" CLEAR IN FRONT
102	LAV	KOHLER "REVIVAL" K-2950	28"Wx19"Dx8 1/8"H		OWNERS CHOICE	W/ MANUFACTURER'S POP-UP DRAIN	
103	SHOWER	OWNERS CHOICE	SEE PLAN		OWNERS CHOICE	PROVIDE BRASS 2" DRAIN	-
104	KITCHEN SINK	KOHLER "BROOKFIELD" K-5942	33"Wx22"Dx8 5/8"H		OWNERS CHOICE	W/ MANUFACTURER'S STRAINER	
105	MC (KOHLER 'CIMARRON'	28 3/4"xl7 5/8"x30 3/4"	À	MANUF. TRIP LEVER		
106	TUB/SHOWER COMB.	OWNERS CHOICE	SEE PLAN		OWNERS CHOICE	W MANUFACTURER'S TUB DRAIN W/BUILTIN STOPPER	2
107	LAV	KOHLER "REVIVAL" K-2950	28"Wx19"Dx8 1/8"H		OWNERS CHOICE	W/ MANUFACTURER'S POP-UP DRAIN	
108	LAV	KOHLER "REVIVAL" K-2950	28"Wx19"Dx8 1/8"H	\ /	OWNERS CHOICE	W/ MANUFACTURER'S POP-UP DRAIN	

SYM	ITEM	MANUFACTURE/MODEL	SIZE	COLOR	VALVES/FITTINGS	OTHER FITTINGS	REMARKS
101	REFRIGERATOR	OWNERS CHOICE	OWNERS CHOIC	E OWNERS CHOICE	OPT. WATER LINE	MANUFACTURER'S RECOMMENDED ELECT.	
102/	DISHWASHER	OWNERS CHOICE			HOT WATER CONNECTIO	CONNECTION MANUFACTURER'S RECOMMENDED CONNECTIONS AND DRAW LINE	
103	RANGE EXHAUST HOOD	OMNERS CHOICE			IP GAS	PROVIDE CONNECTIONS PER	PROVIDE VENT T EXTERIOR
104	RANGE	ÓWNERS CHOICE				MANUFACTURER'S RECOMMENDED PROVIDE CONNECTIONS PER MANUFACTURER'S RECOMMENDED	
105	ON-DEMAND WH	OWNERS OPT.			IP GAS	PROVIDE CONNECTIONS PER MANUFACTURER'S RECOMMENDED	
106	FAU	OWNERS CHOICE			LP GAS	MANUFACTURER'S LP GAS CONVERSION	
107	WASHEER/DRYER	BY OWNERS	V			MANUFACTURER'S RECOMMENDED CONNECTIONS AND DRAIN LINE, LP GAS OPT.	PROVIDE VENT 1 EXTERIOR

SYM	ROOM		FLOOR					BASE					WALLS						CEILINGS							AREA	REMARKS	
					•				<u> </u>	FINIS	SH					FINIS	SH								FINISH			
		RESILENT FLR	CARPET	HARDWOOD	ERAMIC TI	EXPOSED CONC. IX STAIN GRADE WOOD TRIM	IX PAINT GRADE MOOD TRIM	COVED FEDAMIC TILE	I	ICOATS STAIN 2 COATS SEAL	ICOAT PRIMER 2 COAT LATEX TRIM PAINT	MANUTACIUKE <i>U SUGGES</i> I SELEK 173" DRYMAII	5/8" DRYWALL	PLASTER	ATEX SEMI-GL05	1 (1) 1	CERAMIC TILE	SMOOTH FINISH LIGHT TEXTURE	ORANGE PEEL TEXTURE	CEILING HEIGTH	1/2" URTWALL 5/8" DRYWALL	EXPOSED BEAMS		LATEX FLAT PAINT	LATEX SEMI-GLOSS PAINT LATEX GLOSS PAINT STAIN AND VARNISH	LIGHT TEXTURE	SQUARE FEET	
	HALL								-						_					81	• • • • •					0	57	
	KITCHEN																			8'						T	99	
	STAIRS												•							VARIES							37	5/8" DRYWALL ON ALL SUPPORTING MEMBERS SEE DET
	CLOSET I																			8'							5	
	GREAT ROOM																		1	VARIES		•	•				221	V=VAULTED CEILING
	BATH ROOM						\							Ť						8'				_		\top	39	
	LAUNDRY				0						_																14	
	BATH				0						(42	
	LIN							•			-																8	
	LAV				•			•								•											33	
	BEDROOM																										265	
	CLOSET						\													>							49	
	LOFT																		.								86SF	V=VAULTED CEILING, SF =HABITAL SF

TAPE, TEXTURE AND PRIME ALL DRYWALL WALLS AND CEILINGS. U.O.N.

O.C. = OWNERS CHOICE

ALL GLAZING TO BE HEAT SMART PLUS SYSTEM 1
WINDOWS TO MEET 2007 CBC EXTERIOR WILDFIRE EXPOSURE FOR STRUCTURES
LOCATED WITIIN A WILDLAND-URBAN INTERFACE FIRE AREA
VERIFY W/ OWNERS ALL FINISHES, APPLIANCE, PLUMBING, DOOR AND WINDOW
INFORMATION

ALL DOOR GLAZING, GLASS TUB AND SHOWER DOORS AND ENCLOSURES, ALL GLAZING WITHIN 18" OF WALKING SURFACES OR 24" OF DOORS, PASSAGEWAYS, STAIRWAYS, OR OTHERWISE DEEMED HAZERDOUS LOCATIONS, SHALL BE APPROVED FULLY TEMPERED, APPROVED SAFTY GLASS OR OTHERWISE SHATTERPROOF MATERIALS AS PER SECTION 2406 UBC.

ALL SKYLIGHTS OR OTHER SLOPED OR HORIZONTAL GLAZING SHALL BE OF APPROVED PLASTIC OR CONSTRUCTED OF FULLY TEMPERED OR SAFTY GLASS CONFORMING TO SECTION 2406 CBC. WHERE ANY SKYLIGHT PANE EXCEEDS 16 SFT OR THE GLAZING IS IN EXCESS OF 12 FT ABOVE A WALKING SURFACE, THE BOTTOM LEVEL SHALL BE OF APPROVED PLASTIC OR LAMINATED SAFTY GLASS UNLESS FULLY PROTECTED BY SCREENING AS PER SECTION 2409.3 UBC. SKYLIGHTS TO BE MOUNTED ON MIN. 4" HIGH CURB & FULLY FLASHED

PROVIDE DIRECT EMERGENCY EGRESS FROM EACH SLEEPING ROOM BY DOOR OR WINDOW HAVING A MIN. CLEAR OPENING OF 5.7 SFT WITH MIN. DIMENSIONS OF 20" WIDE BY 24" HIGH AND MAX. OPENING SILL HEIGTH OF 44" ABOVE THE FINISHED FLOOR AS PER SECTION 1026.4 CBC.

WHERE SUCH EGRESS WINDOW OCCURES BELOW GRADE, PROVIDE A WINDOW WELL HAVING MIN. 9 SFT CLEAR OPENING AND MIN NET DIMENSIONS OF 36" E/W AS PER SECTION 1026.5 CBC.

ALL OPENINGS AND PENETRATIONS IN THE BUILDING ENVELOPE TO BE FULLY CAULKED OR OTHERWISE SEALED TO LIMIT AIR INFILTRATION AS PER CEC SPECS: THESE INCLUDE JOINTS AROUND WINDOW AND DOOR FRAMES, PLUMBING AND WIRING PENETRATIONS, SEAMS BETWEEN SOLE PLATES AND SUBFLOORING, BETWEEN BUILDING PANELS, ETC.

ALL DOORS, WINDOWS, AND ACCESSES BETWEEN CONDITIONED AND UNCONDITIONED AREAS, INCLUDING GARAGES, ENCLOSED OR OPEN PORCHES, ATTICS, AND FURNACE CLOSETS, ARE TO BE FULLY WEATHERSTRIPPED AS PER CEC SPECS.

EXTERIOR WINDOWS SHALL HAVE AT LEAST ONE TEMPERED PANE (WUI)

ARTIN & DORIS SMITH

ITTLE F RIVER,

40633 LITTLE

DRAWING TITLE:

SCHEDULES

DATE: 12/6/10
DRAWN BY: AK - 1009
REVISIONS:
PLAN CHECK REV 2/28/

A6
JOB #: 1017