


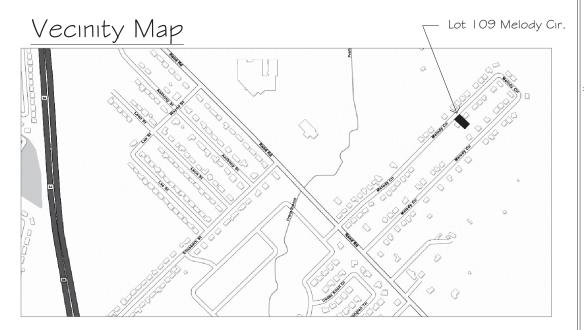

SITE PLAN INFO	RMATION
LOT SIZE	7,560 S.F.
BUILDING AREA	2,517 S.F.
PERCENT LOT COVERED	33.06%

A MINIMUM OF 70% OF THE NON-ROOF AREA OF THE LOT COVERED WILL HAVE LANDSCAPE (GRASS, TREES, ETC.)



# **Aplicable Codes**

2015 IRC 2015 IMC 2015 IEC 2015 IECC 2015 IPC 2014 NEC

# **Project Description**

This project is a new construction of a single family residennce of 1,826 s.f. of living space over concrete slab.



HESE PLANS ARE INTENDED TO PROVIDE BASIC COMPIONSTRUCTION/DESIGN INFORMATION NECESSARY TO COMPINES STRUCTURE. ALL PORTIONS OF THE WORK, INCLUDING HUMBING, MECHANICAL AND ELECTRICAL SHALL BE EFFORMED IN FULL COMPLIANCE WITH ALL APPLICABLE CI COUNTY, STATE AND NATIONAL CODES. BUILDER RESERVES HE RIGHT TO MODIFY THESE PLANS AS REQUIRED. LOCAL HE RIGHT TO MODIFY THESE PLANS AS REQUIRED. LOCAL CODES. ORDINANCES. AND RESTRICTIONS WILL APPLY SHOULD.

Lot 109 Melody Cir. Kaufman, Texas 75142 Harmony Estates, Lot 109


**Date** July 17, 2024

Sheet Title

SITE PLAN

Scale 1/16" = 1'-0" Sheet No.

# WALL LEGEND NEW WALL NEW STONE WALL

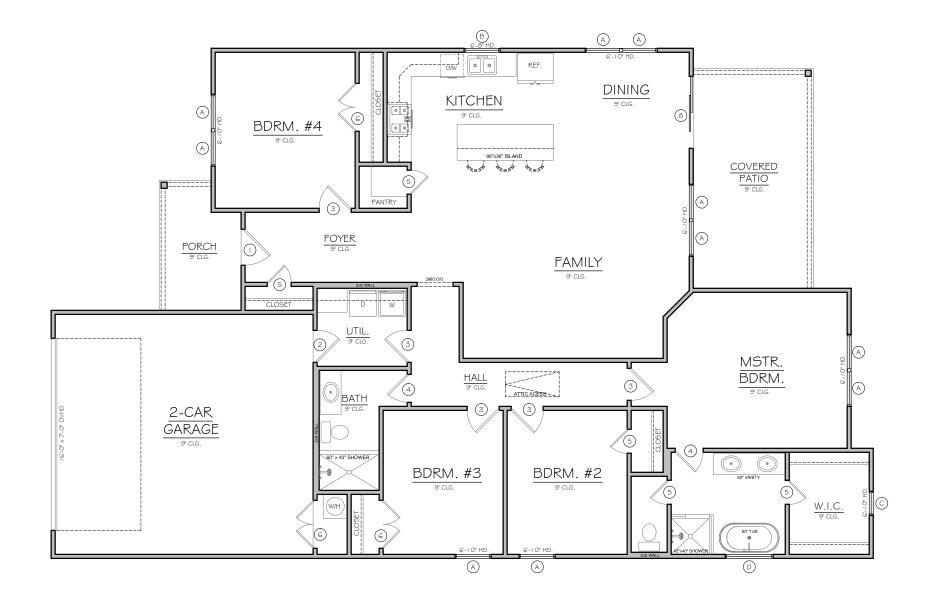

FLOOR PLAN SCALE: 1/8" = 1'-0"

#### GENERAL NOTES

- MANUFACTURE'S SPECIFICATIONS & INDUSTRY STANDARDS.
- 2. ALL WORK MUST BE DONE ACCORDING TO ALL CONCERNED CODE & REGULATIONS.
- 3. A STRUCTURAL ENGINEER MUST BE CONSULTED FOR ALL CONSTRUCTION DETAILS.
- 5. VERIFY CLEARANCES ARE REQUIRED FOR ALL EQUIPMENT.

ULTIMATELY RESPONSIBLE FOR VERIFYING AND MAKING ADJUSTMENTS TO ANY DISCREPANCIES BETWEEN THE PLANS AND THE BUILDING SITE.

D	OOR	SCHEDULE
MK.	SIZE	DESCRIPTION
I	3º68	EXTERIOR METAL
2	2868	EXTERIOR METAL
3	2868	INTERIOR S.C.
4	2468	INTERIOR S.C.
5	2º68	INTERIOR S.C.
6	2º68	INTERIOR S.C. /POCKET
7		
8		

WI	NDOW	' SCHEDULE
MK.	SIZE	DESCRIPTION
Α	3°5°	SINGLE HUNG
В	3°3°	SINGLE HUNG
С	2°2°	SINGLE HUNG
D	4°4°	FIXED/Frosted/Temp.

# SQUARE FOOTAGE

NEW HOUSE (A/C)	1,826 S.F.
Garage Porch	449 S.F.
Porch	64 S.F.
Patio	178 S.F.

TOTAL

UNDER ROOF 2,517 S.F.

- . ALL WORK MUST BE DONE ACCORDING TO
- 4. CONTRACTOR TO FIELD VERIFY BUILDING ELEVATIONS AND EXISTING UTILITIES.
- 6. BEFORE PROCEEDING WITH ANY WORK OR ORDERING ANY MATERIALS, THE CONTRACTOR AND/OR SUBCONTRACTOR SHALL VERIFY ALL MEASUREMENTS AND LOCATIONS OF BUILDING COMPONENTS AND THEIR INTERRELATIONSHIP AT THE BUILDING SITE, AND SHALL BE RESPONSIBLE FOR THEIR CORRECTNESS.

7.CONTRACTOR AND/ OR SUBCONTRACTOR IS

# Lot 109 Melody Cir Kaufman, Texas 75142

Harmony Estates, Lot 109

North


Date July 17, 2024


**Sheet Title** 

FLOOR PLAN

Scale 1/8" = 1'-0"


Sheet No.

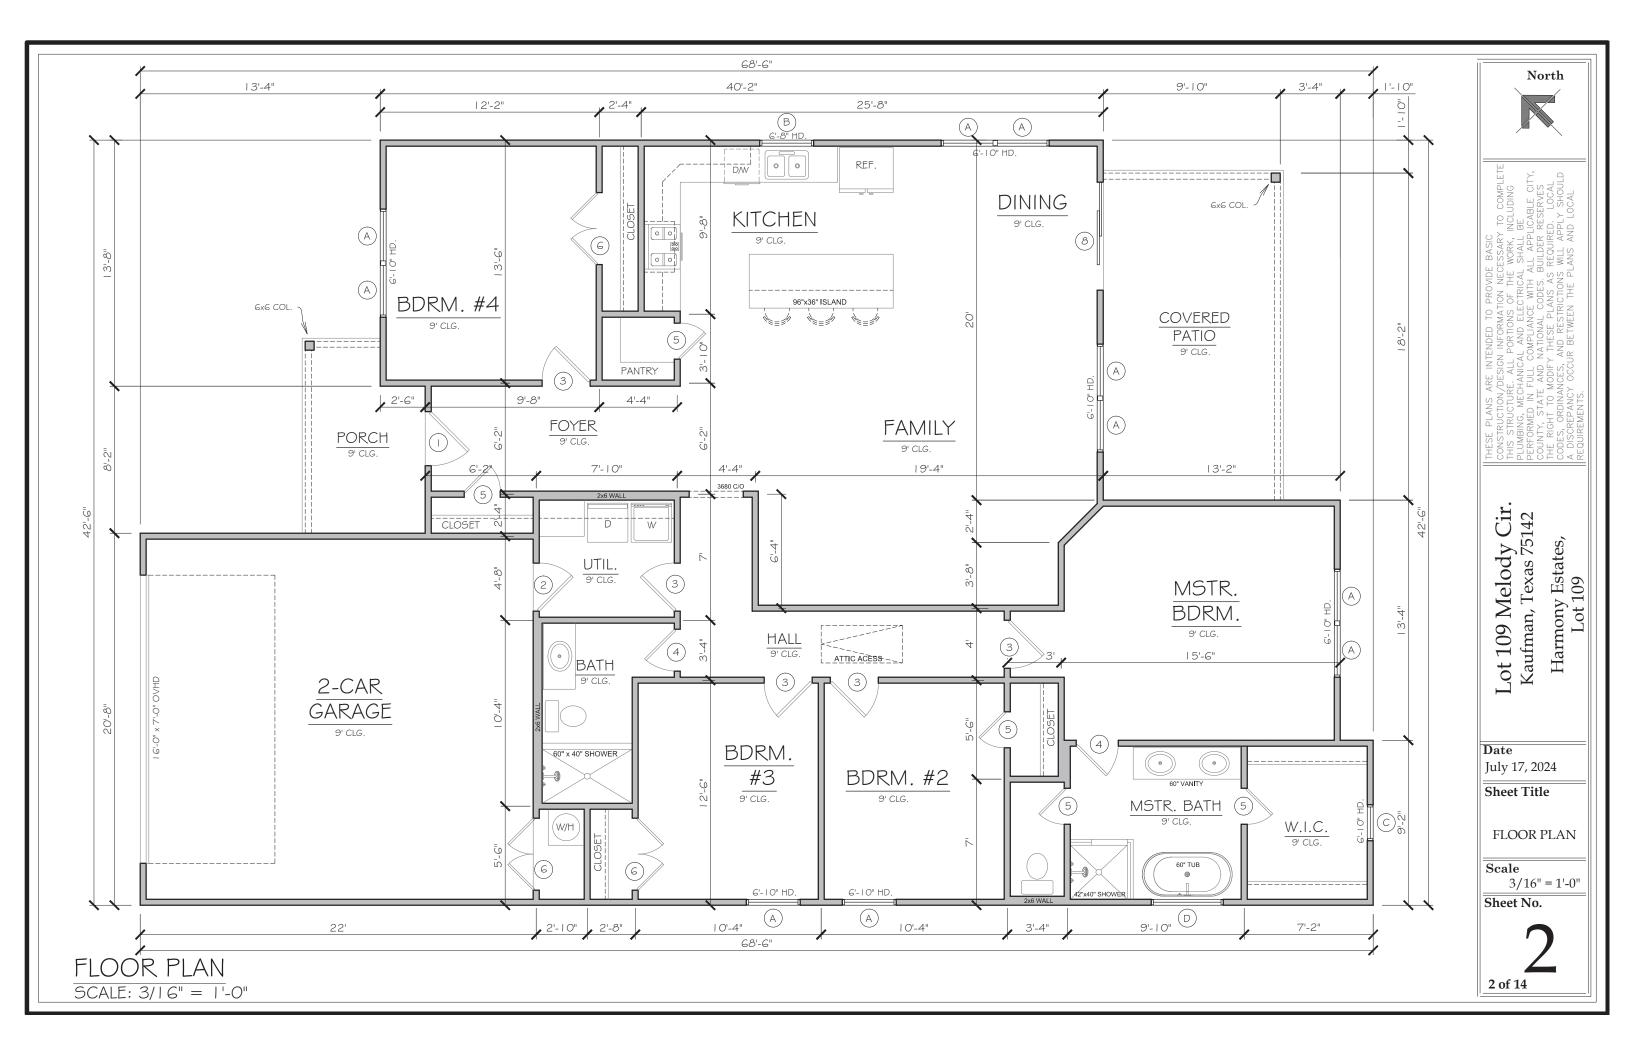

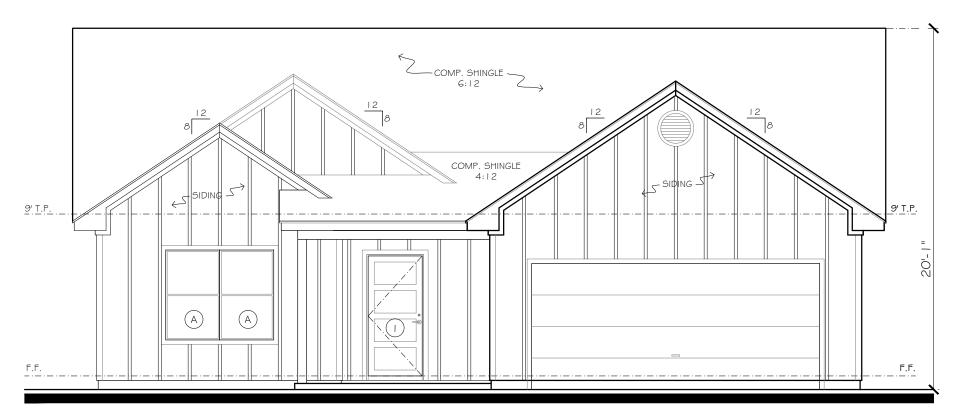

# FRONT ELEVATION

SCALE: 3/16"=1'-0"

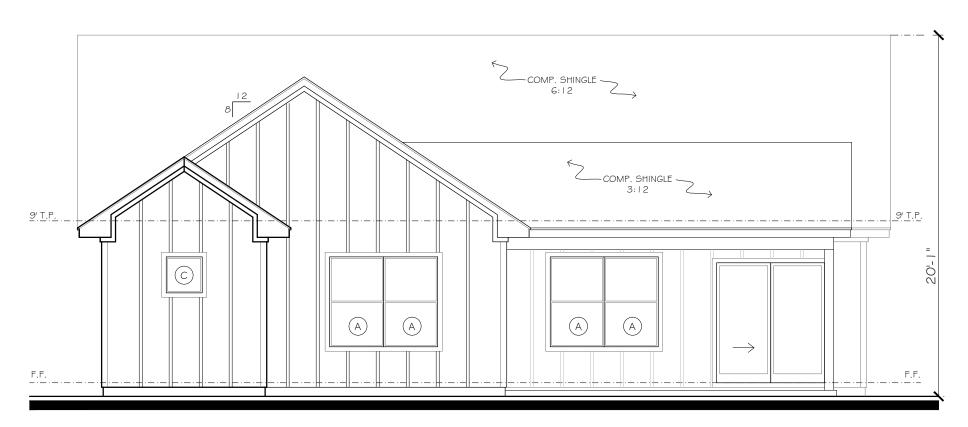

REAR ELEVATION

SCALE: 3/16"=1'-0"

North



Lot 109 Melody Cir. Kaufman, Texas 75142 Harmony Estates, Lot 109

Date


July 17, 2024


**Sheet Title** 


**ELEVATIONS** 


Scale 3/16" = 1'-0"

Sheet No.

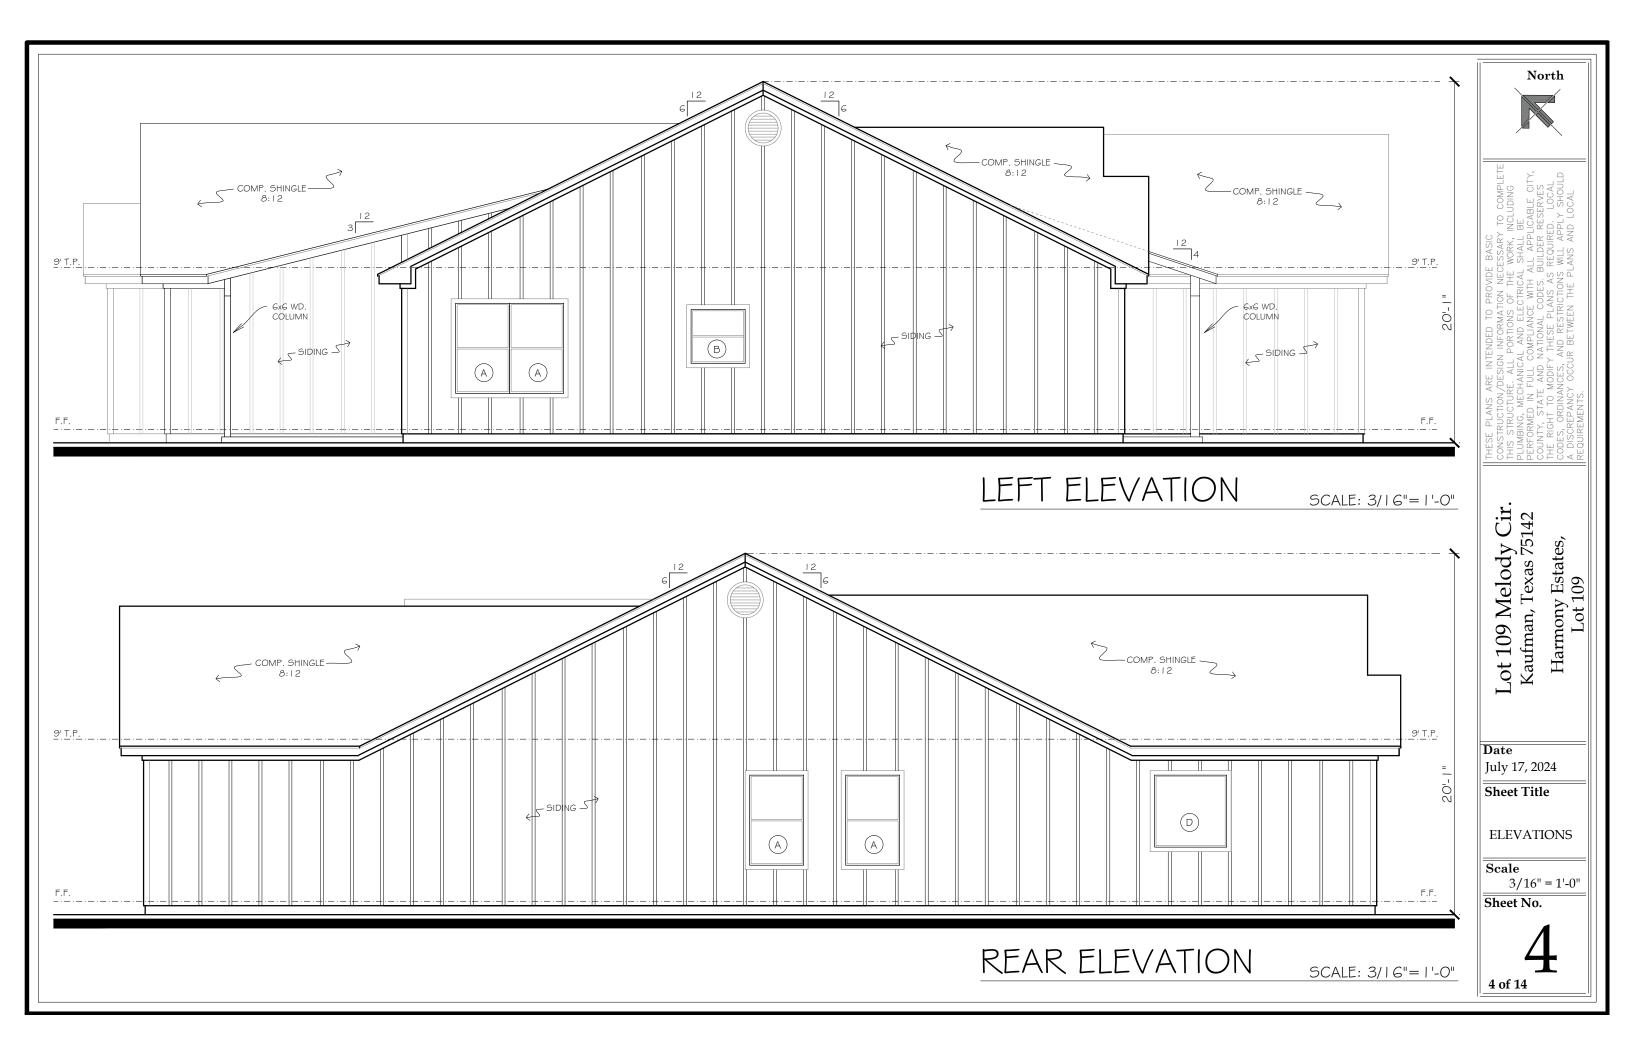

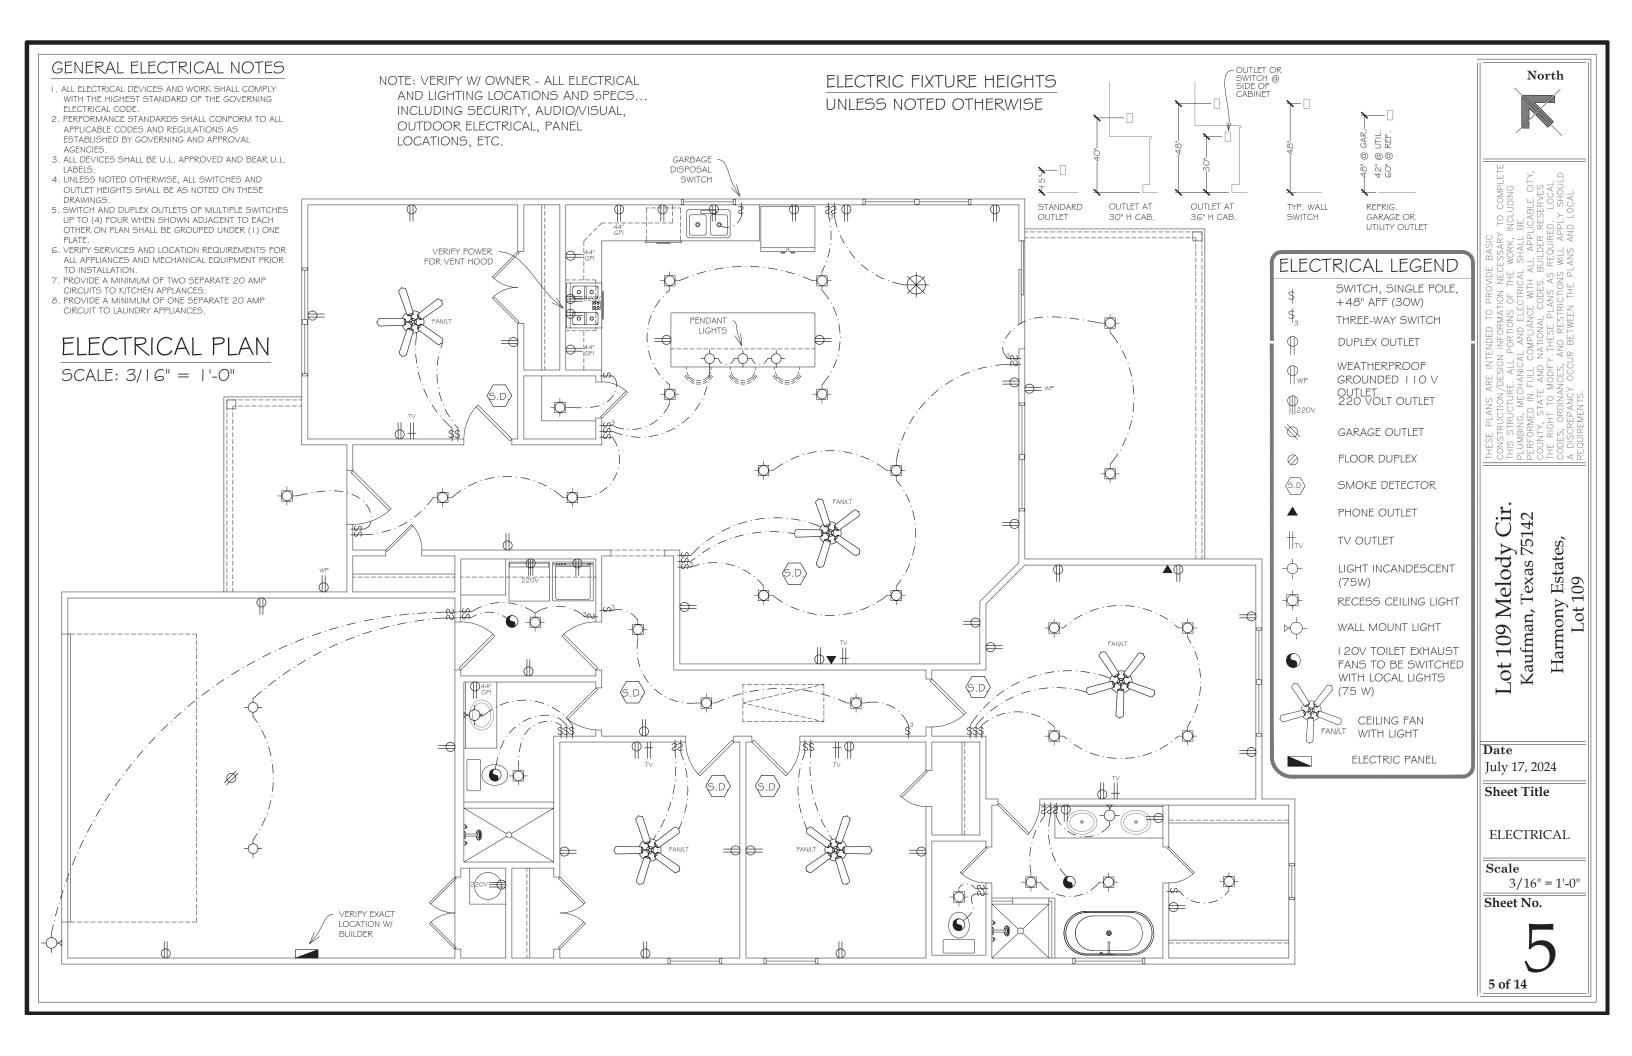

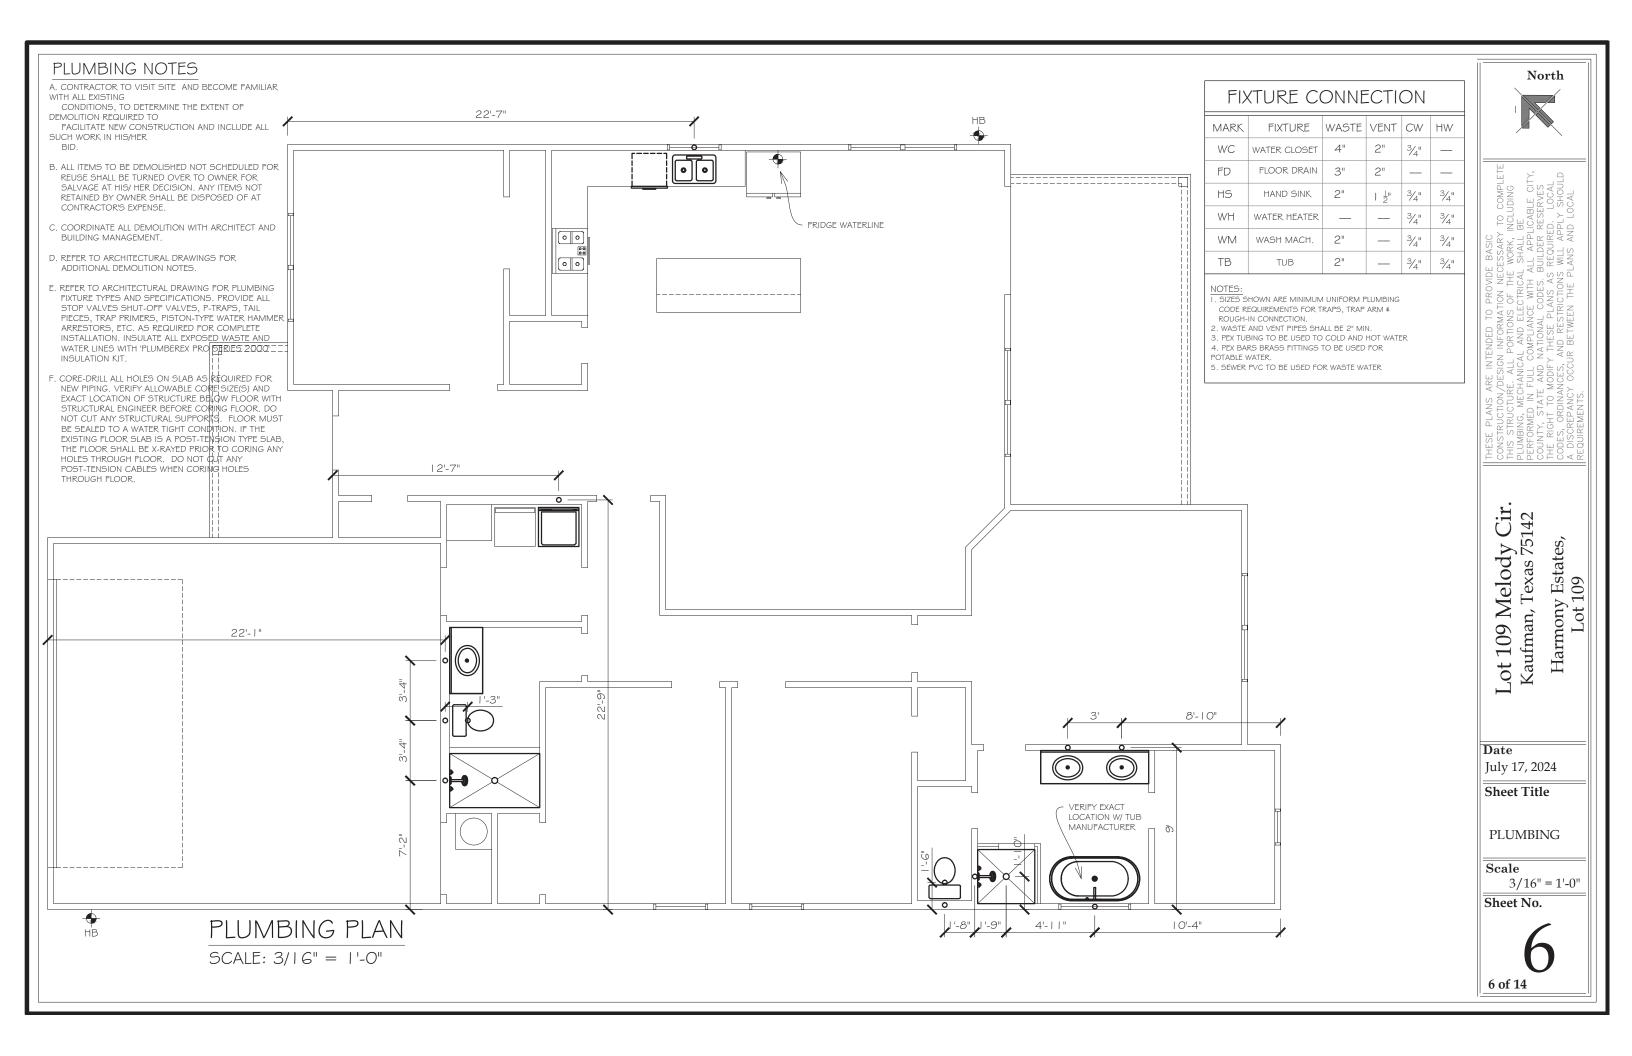

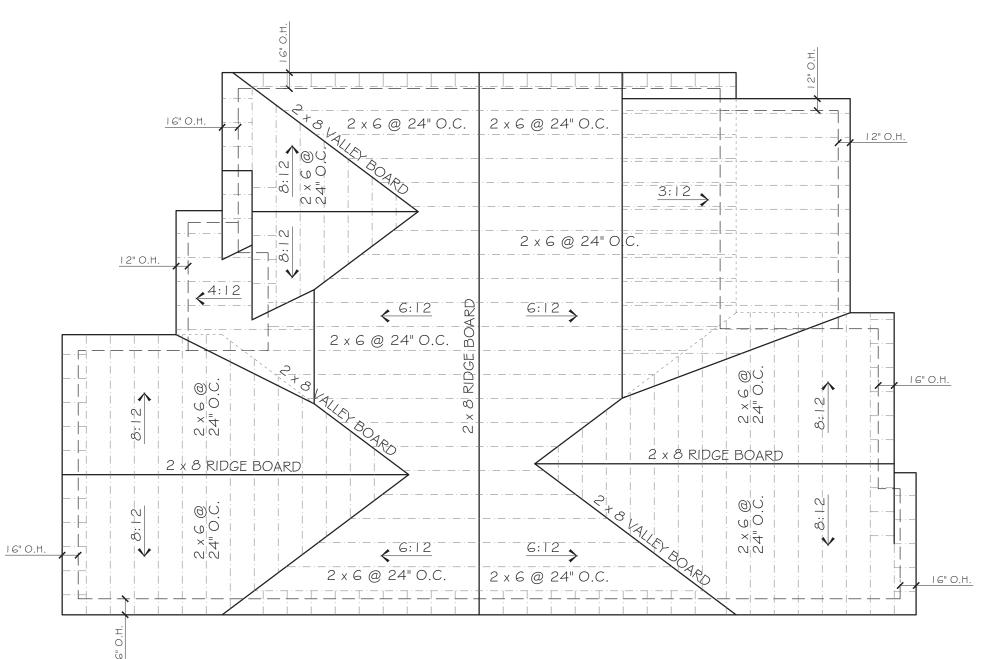

# **ROOF PLAN**

SCALE: 1/8" = 1'-0"

## RAFTER SPAN CHART (SLATE OR TILE ROOF)

REFERENCE=INTERNATIONAL RESIDENCIAL CODE 2015 RAFTERS: CEILING NOT ATTACHED TO RAFTERS. DL = 20 PSF, LL = 20 PSF,  $\triangle = L/180$ 

RAFTERS: CEILING ATTACHED TO RAFTERS,

DL = 20 PSF, LL = 20 PSF,  $\triangle$  = L/240

## SPAN CHART FOR #2 SOUTHERN PINE

		-	EILING N TO RAFT			TERS, C	EILING O RAFT	ERS
	12"	16"	19.2"	24"	12"	16"	19.2"	24"
2 X 4	9'-0"	7'-9"	7'-1"	6'-4"	9'-0"	7'-9"	7'-1"	6'-4"
2 X 6	13'-6"	11'-8"	10'-8"	9'-6"	13'-6"	11'-8"	10'-8"	9'-6"
2 X 8	17'-1"	14'-9"	13'-6"	12'-1"	17'-1"	14'-9"	13'-6"	12'-1"
2 X 10	20'-3"	17'-6"	16'-0"	14'-4"	20'-3"	17'-6"	16'-0"	14'-4"
2 X 12	23'-10"	20'-8"	18'-10"	16'-10"	23'-10"	20'-8"	18'-10"	16'-10"

F	ROOF BI	RACING SCHEDULE	
$\Lambda$	HT	REQUIREMENTS	SECTION
	1-8FT.	2X4 "T" BRACING	∑ 2X4 2X4
TYPICAL	9-16FT.	2XG/2XG "T" BRACING	∑ 2X6 2X6
ROOF BRACING	17-25FT.	2X8/2X8 "T" BRACING	∑ 2X8 2X8

# NOTES, ROOF BRACING

I. RAFTERS, RIDGES, HIPS AND VALLEYS SHALL BE #2 SOUTHERN

PINE OR EQUAL.

- 2. RIDGE, HIP, VALLEYS, AND PURLIN LOADS SHALL BE DISTRIBUTED TO WALLS OR BEAMS BELOW BY "T" BRACES OF (2) 2X6'S. THE "T" BRACES SHALL BE INSTALLED AT AN ANGLE GREATER THAN 45 DEGREES WITH THE HORIZONTAL. BRACE PURLINS AT 4'-0" O.C.
- 3. RAFTER SPANS EXCEEDING 11'-8" WITH THE HORIZONTAL SHALL BE BRACED WITH A 2X6 PURLIN.
- 4. USE 2X6 RAFTERS @ 24" O.C. UNLESS NOTED OTHERWISE. ALTERNATELY, USE THE SPAN CHARTS PROVIDED.
- 5. NAIL RAFTERS TO RIDGE, VALLEYS, AND HIP USING 4= I 6D COMMON TOE NAILED OR 3 = 16D COMMON FACE NAILED MINIMUM.
- 6. TOE NAIL ALL CEILING JOISTS TO TOP PLATE USING 3 10D COMMON, NO MORE THAN 2 NAILS SHALL BE INSTALLED ON EACH SIDE OF A JOIST WITH 2X4 TOP PLATE AND NO MORE THAN 3 NAILS INSTALLED ON EACH OF JOIST WITH A 2X6 TOP
- 7. ALL SPLICED RAFTERS SHALL BE SPLICED AND BRACED AT PURLIN LOCATION.

North

Lot 109 Melody Cir Kaufman, Texas 75142 Harmony Estates, Lot 109

Date July 17, 2024


**Sheet Title** 

**ROOF PLAN** 


Scale

1/8" = 1'-0"


Sheet No.

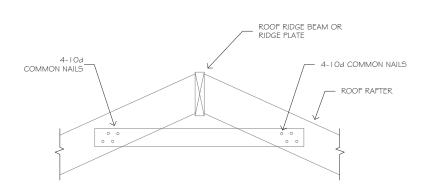



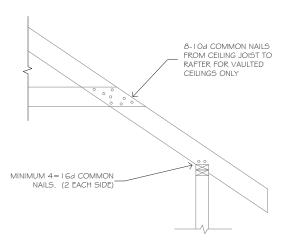




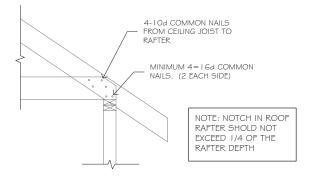


# TYPICAL ROOF RAFTER ATTACHMENT TO TOP PLATE


T-BRACE	
FLANGE SIZE	WEB SIZE
	2x4
2x4	2x4
2x4	2x6
2x6	2x6
2x6	(2)2x6
	FLANGE SIZE 2x4 2x4 2x6

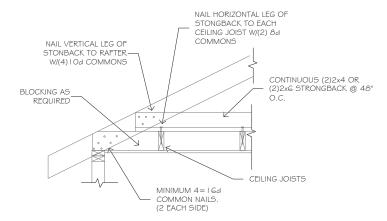


CEILING JOIST PERPENDICULAR TO ROOF RAFTER

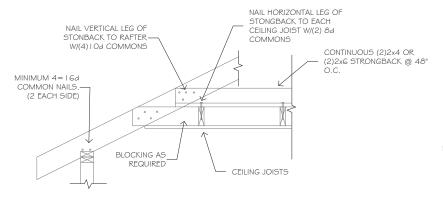

VAULTED CLG. W/ CLG. JOIST PERPENDICULAR TO RAFTERS

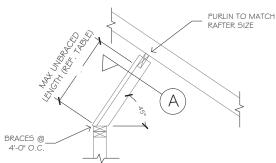

ROOF PURLIN SUPPORT DET.

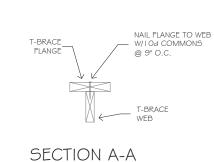

TYP. "T" BRACE



North

SABLE CITY ESERVES LOCAL Y SHOULD

Lot 109 Melody Cir Kaufman, Texas 75142 Harmony Estates, Lot 109


Date July 17, 2024

**Sheet Title** 

**DETAILS** 

Scale

1/8" = 1'-0" **Sheet No.** 

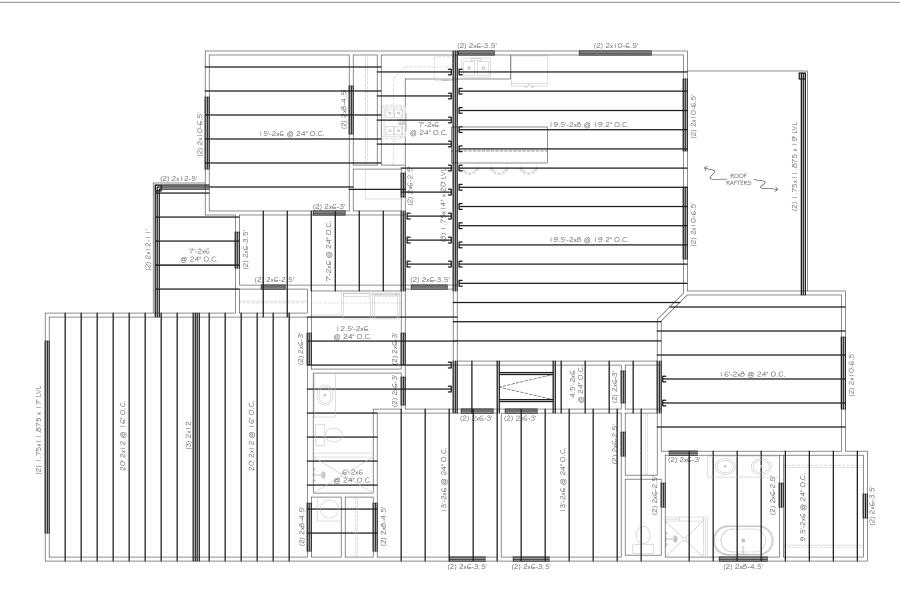

# FRAMING PLAN

SCALE: 1/8" = 1'-0"

## REF. INTERNATIONAL RESIDENTIAL CODE 2015

CEILING JOISTS: UNINHABITABLE ATTICS WITH LIMITED STORAGE,

DL = 5psf LL = 10psf,  $\triangle = L/240$ DL = 10psf LL = 20psf,  $\triangle = L/240$ 

# SPAN CHART FOR #2 SOUTHERN PINE

	DEA	ING JOI D LOAD LOAD :	= 5		D	EILING . EAD LO VE LOA	AD = I	-
	12"	16"	19.2"	24"	12"	16"	19.2"	24"
2 X 4	11'-10"	10'-9"	10'-2"	9'-3"	9'-3"	8'-0"	7'-4"	6'-7"
2 X 6	18'-8"	16'-11"	15'-7"	13'-11"	13'-11"	12'-0"	11'-0"	9'-10"
2 X 8	24'-7"	21'-7"	19'-8"	17'-7"	17'-7"	15'-3"	13'-11"	12'-6"
2 X 10	26'-0"	25'-7"	23'-5"	20'-11"	20'-11"	18'-1"	16'-6"	14'-9"
2 X I 2	26'-0"	25'-4"	23'-0"	23'-0"	23'-0"	20'-3"	18'-8"	16'-10"

## HEADER SPAN ALLOWANCE (MAXIMIJM)

	(1017 0 (1101)	× 1 × 1)
(PLY) SIZE	LOAD BEARING	NON-LOAD BEARING
(2) 2X6's	-	4 FT
(2) 2X8's	4 FT	6 FT
(2) 2XIO's	6 FT	8 FT
(2) 2X   2's	8 FT	I O FT

LOAD BEARING HEADERS GREATER THAN 8'-O" NEED TO BE SIZED



2x4 CRIPPLE ABOVE

2x4 SOLE PLATE

1/2" PLYWOOD SPACER

2-2x HEADER SEE PLAN

HEADER SHALL REST ON ONE HEADER STUD @ EACH END FOR OPENINGS LESS THAN 6'-0" WIDE, PROVIDE 2 HEADER STUDS EACH END FOR OPENINGS > 6'-0" WIDE

# TYP. HEADER DETAIL

#### NOTES

- I. ALL CEILING JOISTS TO BE #2 SOUTHERN PINE.
- 2. ALL CEILING JOISTS MUST BE NAILED TO TOP PLATE W/3=8D COMMON NAILS
- 3. ALL CEILING JOISTS MUST BE NAILED TO RAFTER W/9= I 6D COMMON NAILS.
- 4. JOISTS AND BEAM HANGERS. WHERE SPECIFIED. SHALL BE FULLY NAILED PER MANUFACTURER'S CATALOG SPECIFICATIONS.
- 5. DECKING FOR UNINHABITABLE ATTICS WITH LIMITED STORAGE SHALL BE MINUMUM 7/16" PLYWOOD OR OSB, WITH A SPAN RATING THAT MEETS OR EXCEEDS THE CEILING JOIST SPACING.
- 6. MULTIPLE-PLY BEAMS, WHERE SPECIFIED, SHALL HAVE EACH PLYY NAILED TOGETHER WITH 2 ROWS OF 16D COMMONS @ 12" O.C. (3 ROWS OF NAILS REQUIRED FOR BEAMS EXCEEDING 12" MIN. DEPTH)
- 7. ALL MULTIPLE-PLY BEAM CALLOUTS ON PLANS SHALL BE #2 SOUTHERN PINE UNLESS NOTED OTHERWISE.



Lot 109 Melody Cir Kaufman, Texas 75142 Harmony Estates, Lot 109

Date

July 17, 2024

**Sheet Title** 


CEILING FRAMING

Scale

1/8" = 1'-0"

Sheet No.




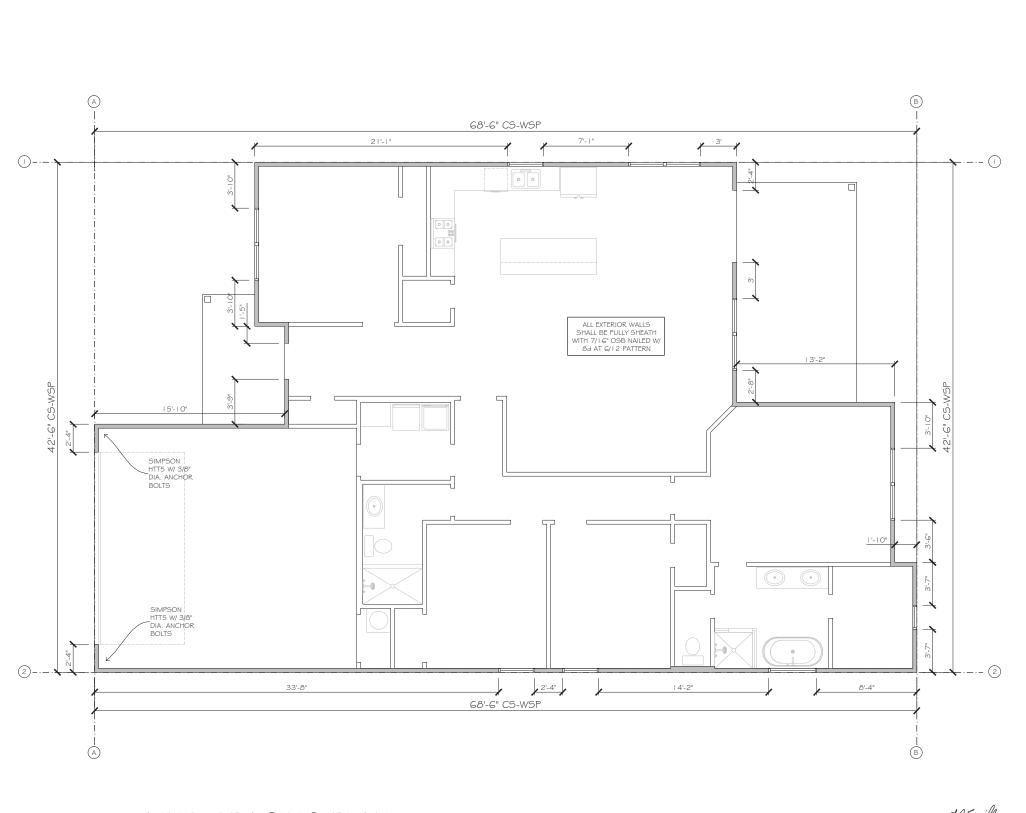

WIND BRACING PLAN

SCALE: 1/8" = 1'-0"



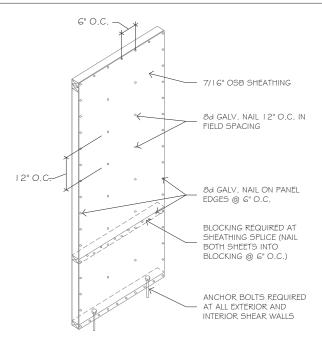

NOTE: FOR SECOND FLOOR WALL ANCHORAGE (OVER WOOD FLOOR), REFER TO FASTENING SCHEDULE

CS-WSP SHEARWALL SHEATHING DETAIL

## WALL BRACING NOTES

- I. ALL WALL BRACING TO COMPLY WITH 2015 IRC OR NEWER BUILDING CODE CURRENTLY ADOPTED BY CITY OF KAUFMAN.
- 2. NAIL "RED" THERMAPLY WITH 1 1/4" GALVANIZED ROOFING NAILS OR 16 GA. 7/16" MIN. CROWN STAPLES SPACED 3" O.C. ON ALL PANEL EDGES AND 6" O.C. IN THE FIELD.

# ALTERNATE TIE DOWN ANCHORS

(USE THESE ANCHORS AFTER THE SLAB IS CURED)

- I. LOCATE HTT5 SIMPSON TIES AT CORNERS O THE "A" WALL BRACING PANELS AS NOTED ON WALL BRACING PLANS.
- 2. DRILL INTO SLAB WITH 3/4" DIA. DRILL BIT. HOLES SHOULD BE DRILLED 4" DEEP MIN.
- 3. HOLES SHOULD BE CLEANED WITH COMPRESSED AIR AND BRUSH IN EACH HOLE. ALL CONCRETE DUST MUST BE REMOVED FROM HOLES
- 4. IN EACH HOLE, INJECT SIMPSON ACRYLIC-TIE ADHESIVE PER MANUFACTURER'S REQUIREMENTS.
- 5. INSTALL 5/8" X I 2" THREADED ROD INTO EACH HOLE (SIMPSON RB#5X12). DO NOT DISTURB THREADED ROD FOR AT LEAST TWO HOURS TO ALLOW GLUE TO CURE.
- 6. AFTER WAITING FOR GLUE TO CURE, INSTALL SIMPSON HTT5 TIES AND NAIL TO STUDS WITH 32, 16D NAILS.

North

ABLE CIT

Lot 109 Melody Cir. Kaufman, Texas 75142 Harmony Estates, Lot 109

Date July 17, 2024


**Sheet Title** 


WIND BRACING

Scale

1/8" = 1'-0"

Sheet No.

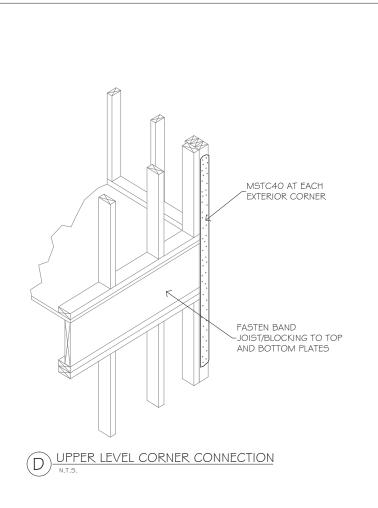

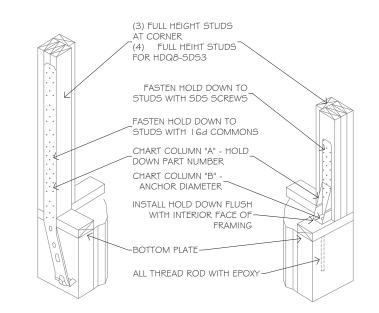


HTT5 AND HDQ8-SDS3 SET-XP EPOXY

DETAIL IA, IB, AND IC LOWER HOLD DOWNS						
PLAN SPEC	"A" PART NO	"B" Ø (IN)	"C" EMBED MIN (IN)			
IA	STHD14	WET SET	14.0			
ΙB	HTT4/HTT5	5/8" Ø	6.0			
IA	HDQ8-SDS3	7/8" Ø	10.0			
HOLD DOWNS MAY BE INSTALLED ON ANY						


FACE OF STUD BANK AS LONG AS THE VERTICAL LOAD PATH IS CONTINIOUS


12" x 12" WOOD POST POST BASE, SEE SCHEDULE


WOOD COLUMN FOOTING

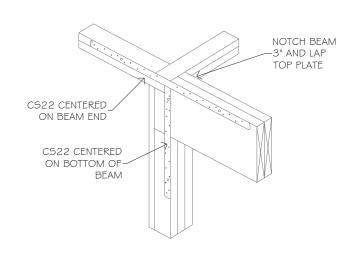

A FLUSH TOP PLATE

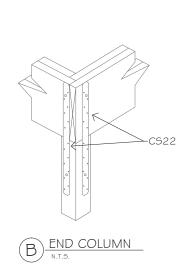

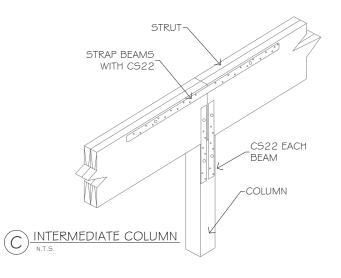

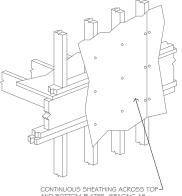

PANEL CONNECTION DETAIL AT FIRST \$ SECOND FLOORS



North

Lot 109 Melody Cir. Kaufman, Texas 75142 Harmony Estates, Lot 109

Date July 17, 2024


**Sheet Title** 

**DETAILS** 


Scale

1/8" = 1'-0"


Sheet No.

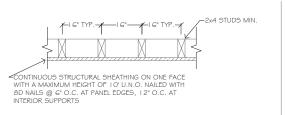




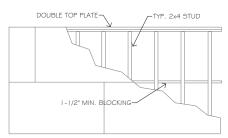


PANEL BLOCKING DETAIL

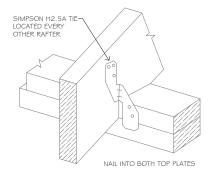

RAFTER TO TOP PLATE DETAIL

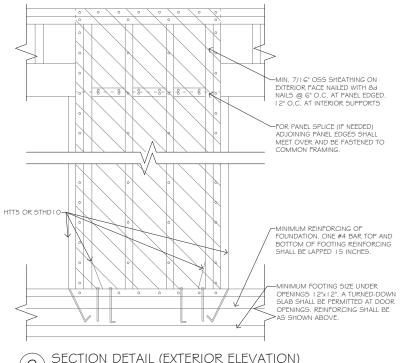

SECTION DETAIL (EXTERIOR ELEVATION)

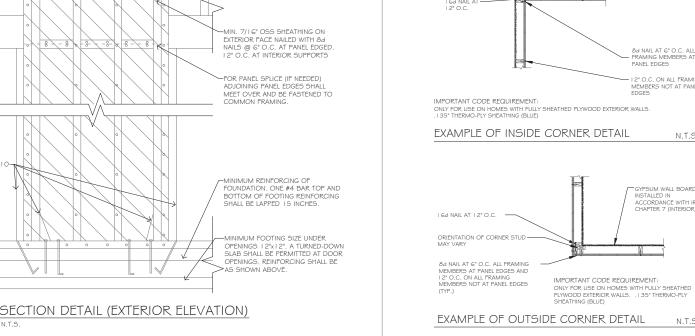

INSTALLED IN ACCORDANCE WITH IRC CHAPTER 7 (INTERIOR) OF CORNER STUD MAY 2" O.C. ON ALL FRAMING MEMBERS NOT AT PANEL EDGES N.T.S.

PSUM WALL BOARD

#### GENERAL NOTES

- REFERENCE ARCHITECTURAL DRAWINGS FOR STUD SIZES AND
- ALL RAFTERS/LEDGERS, STUDS, HEADERS AND SHEATHING SHALL BE NAILED IN ACCORDANCE WITH THE 2015 \$ 2018 IRC TABLE RG02.3(1), UNLESS OTHERWISE NOTED.
- NAILLU IN ACCURDANCE WITH THE 2015 \$ 2016 INC. TABLE REGUZ.3(1), UNLESS OTHERWISE NOTED.

  3. SEAWALL SEGMENTS SHALL BE CONTINUOUS FROM THE MUDSLIDE THROUGH THE DOUBLE TOP PLATE.

  4. BRACE WALLS LESS THAN 2' IN WIDTH DO NOT REQUIRE BOLTS \$ WASHERS BETWEEN THE 2 INSTALLED HOLD DOWN STRAPS (HTTS)STHDIO), PROVIDE I -ANCHOR BOLT C/L OR 2-3' PINS AND WASHERS (SET @ 1/3 POINTS BY A POWDER ACTUATED TOOL) FOR BRACED WALLS FROM 2' TO 2-8' OVERALL LENGTH.

  5. MUDSLIDE AT ALL EXTERIOR WALLS SAHLL BE ANCHORED TO THE FOUNDATION SLAB WITH 1/2" ANCHOR BOLTS EMBEDDED 7" INTO THE SLAB AND SPACED 6-0" O.C., MAX. OR SIMPSON STRONG-TIE MASA MUDSLIDE ANCHORS @ 6-0" O.C.,

  6. WHERE RAFTERS MEET THE TOP PLATE OF EXTERIOR WALLS, INSTALL SIMPSON STRONG-TIE H2.5 ANCHORS AT EVERY OTHER RAFTER. ANCHORS WITH 445 LB. CAPACITY OR GREATER MAY BE USED AS AN ALTERNATE.

- ALTERNATE.

  7. ALI INTERIOR WALLS TO BE 1/2" SHEETROCK NAILED PER TABLE RG02.3(1)

  OF THE 2000, 2003, 2006, 2009, 2012 \$ 2015 IRC.

  8. LET-IN BRACING MAY BE SUBSTITUTED WITH 4X8 STRUCTURAL SHEATHING

  (RED T-HLY OR OSB) FROM TOP TO BOTTOM PLATE OR CS 16 X-BRACING.

  9. ALL INTERIOR BRACED WALLS MUST BE ANCHORED TO THE FOUNDATION

  USING SIMPSON TITEN HD 1/2" ANCHOR BOLTS OR APPROVED EQUAL.
- 9. I INSTALL TITEN HD ANNCHOR BOLTS AT MAXIMUM SIX FEET ON
- CENTER, WITH MINIMUM 2-3/4" EMBEDMENT INTO FOUNDATION 9.2 MINIMUM TWO BOLTS PER BRACED WALL SECTION, WITH ONE BOLT LOCATED NOT MORE THAN 12" OR LESS THAN SEVEN BOLT DIAMETERS FROM EACH END OF BRACED WALL SECTION.

NOTE: SIMPSON STHD 10 OR HTT5 CAN BE ROTATED 90°

MAY BE SUBSTITUTED WITH APPROVED EQUAL

-EXTEND OF HEADER (DOUBLE PORTAL FRAME)--EXTEND OF HEADER (SINGLE PORTAL FRAME) MIN. 3" x 11.25" NET HEADER


SECTION DETAIL (PLAN VIEW)

─¹YPICAL (ONE STORY) 2'-8' TO 4'-0' LENGTH 7/I 6' OSB STRUCTURAL WOOD
SHEATHING ON ONE FACE WITH A MAXIMUM HEIGHT OF 10' NAILED FER 2000,
2003, 2006, 2009, 2012 \$ 42015 INC TABLE R602.3(1) AND BLOCKED AT
ALL EDGES. TWO ANCHOR BOLTS OR 3' PINS AND WASHERS SET BY POWER


ACTUATED TOOL SHALL BE INSTALLED AT QUARTER POINTS AS SHOWN


HTT5 OR STHD I C

#### SIDE-LOADED MULTIPLE MEMBER CONNECTION SCHEDULE NAILED THROUGH- STRUCTURAL WOOD ASSEMBY TYPE CONN. BOLTED CONN. SCREW CONN. 3 ROW5 12d 2 ROW5 1/2" DIA 2 ROWS 1/4" DIA x 3 ASSEMBLY A OMMON WIRE 1/2" LONG SCREWS AT AT 12" O.C. AILS AT 12" O. 2 ROWS 1/2" DIA. BOLTS W/ WASHERS AT 12" O.C. NOT APPLICABLE NOT APPLICABLE ASSEMBLY B

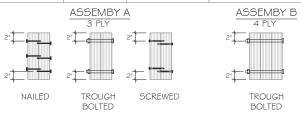

LVL BEAM ASSEMBLY

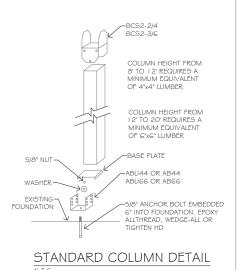

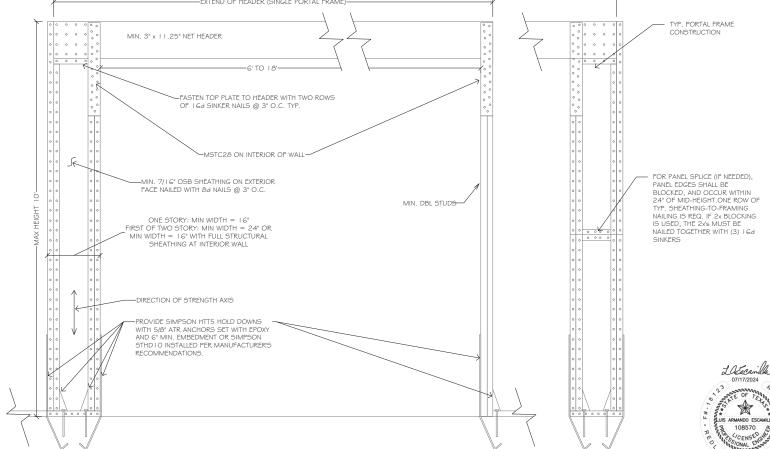

PORTAL FRAME (SINGLE AND DOUBLE)

North



ABLE CIT SERVES LOCAL

Melody Cir. y Estates, 109 Kaufman, Texas Harmony

Lot

Date July 17, 2024

109


ot

**Sheet Title** 

WIND BRACING

Scale

N.T.S. Sheet No.

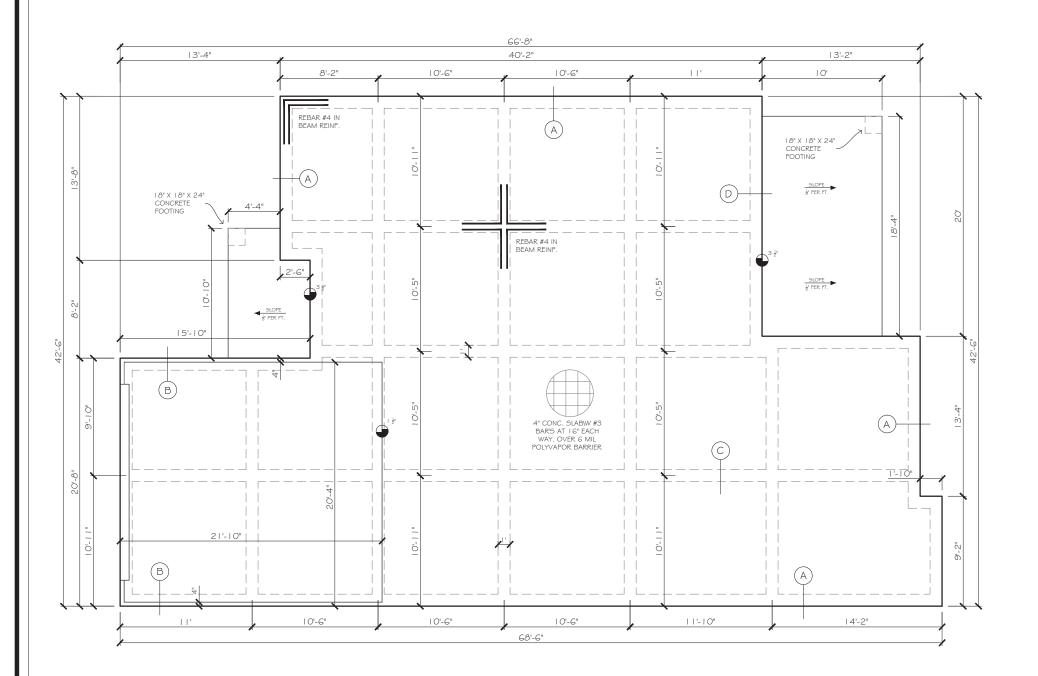

# FOUNDATION PLAN

SCALE: 1/8" = 1'-0"



BELOW SLAB.

- A. EXCAVATE EXISTING SOIL +/- 6" DEEP TO 24" DEEP AND REMOVE TO OFF SITE
- LOCATION
  B. FOUNDATION SLAB SHALL BE 4" THICK OFF 3,000 PSI REINFORCED CONCRETE.
- C. CONCRETE SLAB SHALL BE PLACED OVER 4" THICK SAND AND APPLY LAYER OF 4 MIL THICK VAPOR VARRIER OF POLYETHYLENE
- D. UNDISTURBED SOIL SHALL BE COMPACTED TO 90% PROCTOR PRIOR TO PLACEMENT OF SAND CUSHION.

  E. ALL CONCRETE BEAM SHALL BE 12" WIDE AND 24" DEEP WITH REINFORCING AS INDICATED.
- F. AT ALL BEAM INTERSECTIONS. SHALL HAVE #3 CORNER BAR REINFORCING AND SHALL LAP BEAM REINFORCING NOT LESS
- G. ALL CONCRETE SHALL HAVE A MINIMUM 28 DAY, 3,000 PSI COMPRESSIVE STRENGTH.
  H. ADMIXTURES CONTAINING CHLORIDES, SULPHATE, NITRATES AND
- FLY ASH ARE NOT PERMITED.
- I. REINFORCING STEEL SHALL BE NEW BILLET STELL CONFORMING TO ASTM A-65, GRADE 60, EXCEPT No. 3 BARS MAY BE GRADE 40.
- J. FURNISH AND INSTALL EXPANSION JOINT BETWEEN EXISTING CONCRETE SLAB AND NEW CONCRETE SLAB.
- K. NEW SLAB TO HAVE SMOOTH TOP FINISH
- L. REMOVE FORM BOARDS AND RUB OUT ANY HONEYCOMB AREAS.
- M. FILL IN AROUND NEW CONCRETE WITH NATIVE SOIL.

CONCRETE NOTES

North

SABLE CITY
ESERVES
LOCAL
Y SHOLLL

Lot 109 Melody Cir Kaufman, Texas 75142 Harmony Estates, Lot 109

Date July 17, 2024

**Sheet Title** 

**FOUNDATION** 


Scale

3/16" = 1'-0"

Sheet No.


13 of 14

MINIMUM 1" DIAMETER ANCHOR BOLTS ARE TO BE INSTALLED EVERY 6'-0" O.C. MAX. AND WITHIN 12" OF EACH CORNER EMBEDDED MIN 7" INTO CONCRETE. ATTACHMENT IS REQUIRED WITHIN 4"- I 2" OF EACH BUTT JOINT IN THE BOTTOM PLATE OF ALL EXTERIOR WALLS NOT MORE THAN I 2" OR 7 BOLT DIA. FROM EACH END OF EACH PLATE SECTION. REFER TO BRACED WALL PLAN FOR INTERIOR BRACED WALL ANCHORAGE TO SLAB.

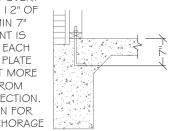


ANCHOR BOLT DETAIL WITH BRICK LEDGE (ONLY IF CODE REQUIRES ANCHOR BOLT




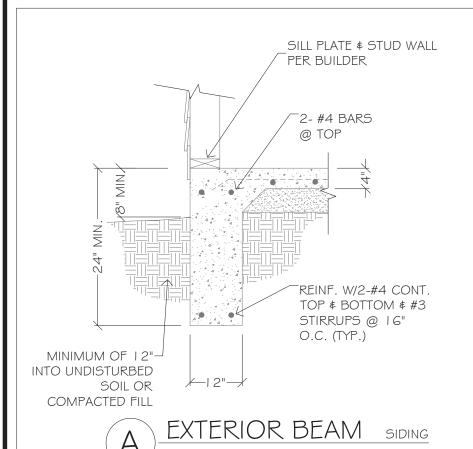




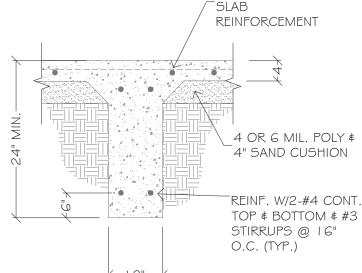




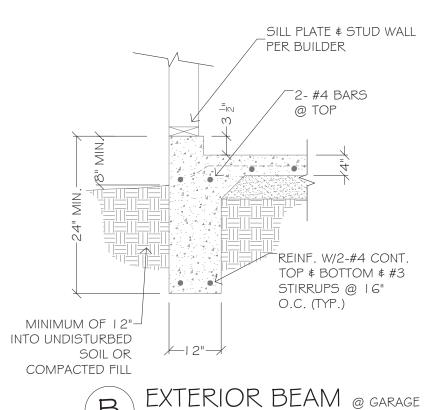

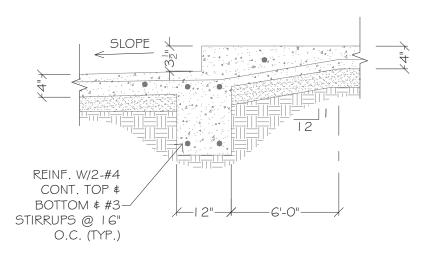

D SLAB TRANSITION @ PATIO N.T.S.

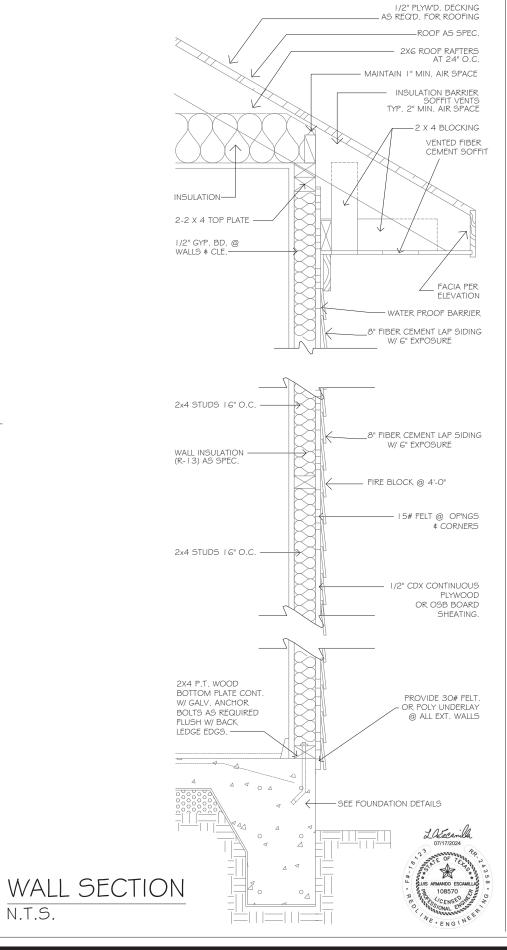

North

HESE PLANS ARE INTENDED TO PROVIDE BASIC

ONSTRUCTION/DESIGN INFORMATION NECESSARY TO COMPLE

HIS STRUCTION ALL PORTIONS OF THE WORK, INCLUDING

UMBING, MECHANICAL AND ELECTRICAL SHALL BE

ERFORMED IN FULL COMPLIANCE WITH ALL APPLICABLE CITY

SOUNTY, STATE AND NATIONAL CODES, BULIDER RESERVES

BE ONLY AND MATICAL CODES, BULIDER RESERVES

FOR ALL TA MANIEY THESE DI MAS AS BECAUSED.

Lot 109 Melody Cir. Kaufman, Texas 75142 Harmony Estates, Lot 109

**Date** July 17, 2024

**Sheet Title** 

FOUNDATION

Scale

N.T.S. Sheet No.

 $\underset{\scriptscriptstyle{14\text{ of }14}}{14}$